

Acre Acre Acre Albert Street - 55 Albert St, Brunswick East Town Planning Submission September 16, 2025 Acre Acre Acre 3/4 Brown St. Collingwood VIC 3066 Aus acre.com.au Acre Acre Acre TP-1.02 Contents

CONTENTS

TP-1.03	Project Steps
TP-2.00	Landscape Plans
TP-2.01	Landscape Concept Plan - Ground Level
TP-2.02	Landscape Concept Plan - Level 1
TP-2.03	Landscape Concept Plan - Level 2
TP-2.04	Landscape Concept Plan - Level 3
TP-2.05	Landscape Concept Plan - Level 4
TP-2.06	Landscape Concept Plan - Roof Level
TP-2.07	Landscape Concept Plan - Roof Level
TP-3.00	Planting
TP-3.01	Plant Palette - Ground Level & Courtyard
TP-3.02	Plant Palette - Upper Terraces
TP-3.03	Plant Palette - Rooftop
TP-3.04	Planting Plan - Ground Level
TP-3.05	Planting Plan - Level 1
TP-3.06	Planting Plan - Level 2
TP-3.07	Planting Plan - Level 3
TP-3.08	Planting Plan - Level 4
TP-3.09	Planting Plan - Roof Level
TP-3.10	Total Plant Schedule
TP-4.0	Irrigation
TP-4.01	Irrigation Plan - Ground Level
TP-4.02	Irrigation Plan - Level 1
TP-4.03	Irrigation Plan - Level 2
TP-4.04	Irrigation Plan - Level 3
TP-4.05	Irrigation Plan - Level 4
TP-4.06	Irrigation Plan - Roof Level
TP-5.0	Elevations
TP-5.01	Elevation - South
TP-5.02	Elevation - East
TP-5.03	Elevation - West
TP-6.0	Typical Details
TP-6.01	Typical Planter Details
TP-7.0	Next Steps

TP-1.03 Project Steps

1.0 Project Briefing - Completed

2.0 Schematic Design (SD) - (Current Stage)

- _ Create a base plan from site analysis and/or any supplied documentation
- _ We undertake internal design workshops and sketch sessions to meet requirements for the project
- _ Produce scaled coloured concept plan which includes overall landscape concepts
- _ Create design precedence visualisation boards to illustrate concept outcomes
- _ Presentation meeting to show concept ideas and direction for the project
- _ Changes to the plans following client feedback if required (1 x Revision included)
- _ Full planting plan and purchase schedule with reference images
- _ Irrigation Zoning Plans

3.0 Design Development (DD)

- Scaled hard structure plans for the purpose of concept refinement and material selection
- Full planting plan and purchase schedule with reference images
- Material specifications and furniture selections
- Garden lighting plan including locations, quantities and fitting specifications
- Coloured elevations of key landscape vistas to convey concept where required
- Photo realistic landscape overview renders

4.0 Construction Details (CD)

- Proposed Construction Plans
- Dimensioned paving and hard structure(s) set-out plans if required
- Dimensioned sections and elevations where required
- Construction details of all architectural landscape elements
- As required, pool shell plans for contractor pricing and pool engineers
- Drawing submitted for engineering, building permits and tendering



Sheet Title: Landscape Concept Plan-Ground Level Date: September 16, 2025 Revision: 4 Neometro Address: 55 Albert St, Brunswick East Page Size: A1 Drawn by: WD Checked by: BR Page: TP-2.01

Client:

ALBERT STREET

1 Landscape Plan - Level 1 Scale: 1:100

VOID

VOID

VOID

VOID

VOID

VOID

Checked by: BR

September 16, 2025

TP-2.02

Page:

ш


S

S

S

0

C

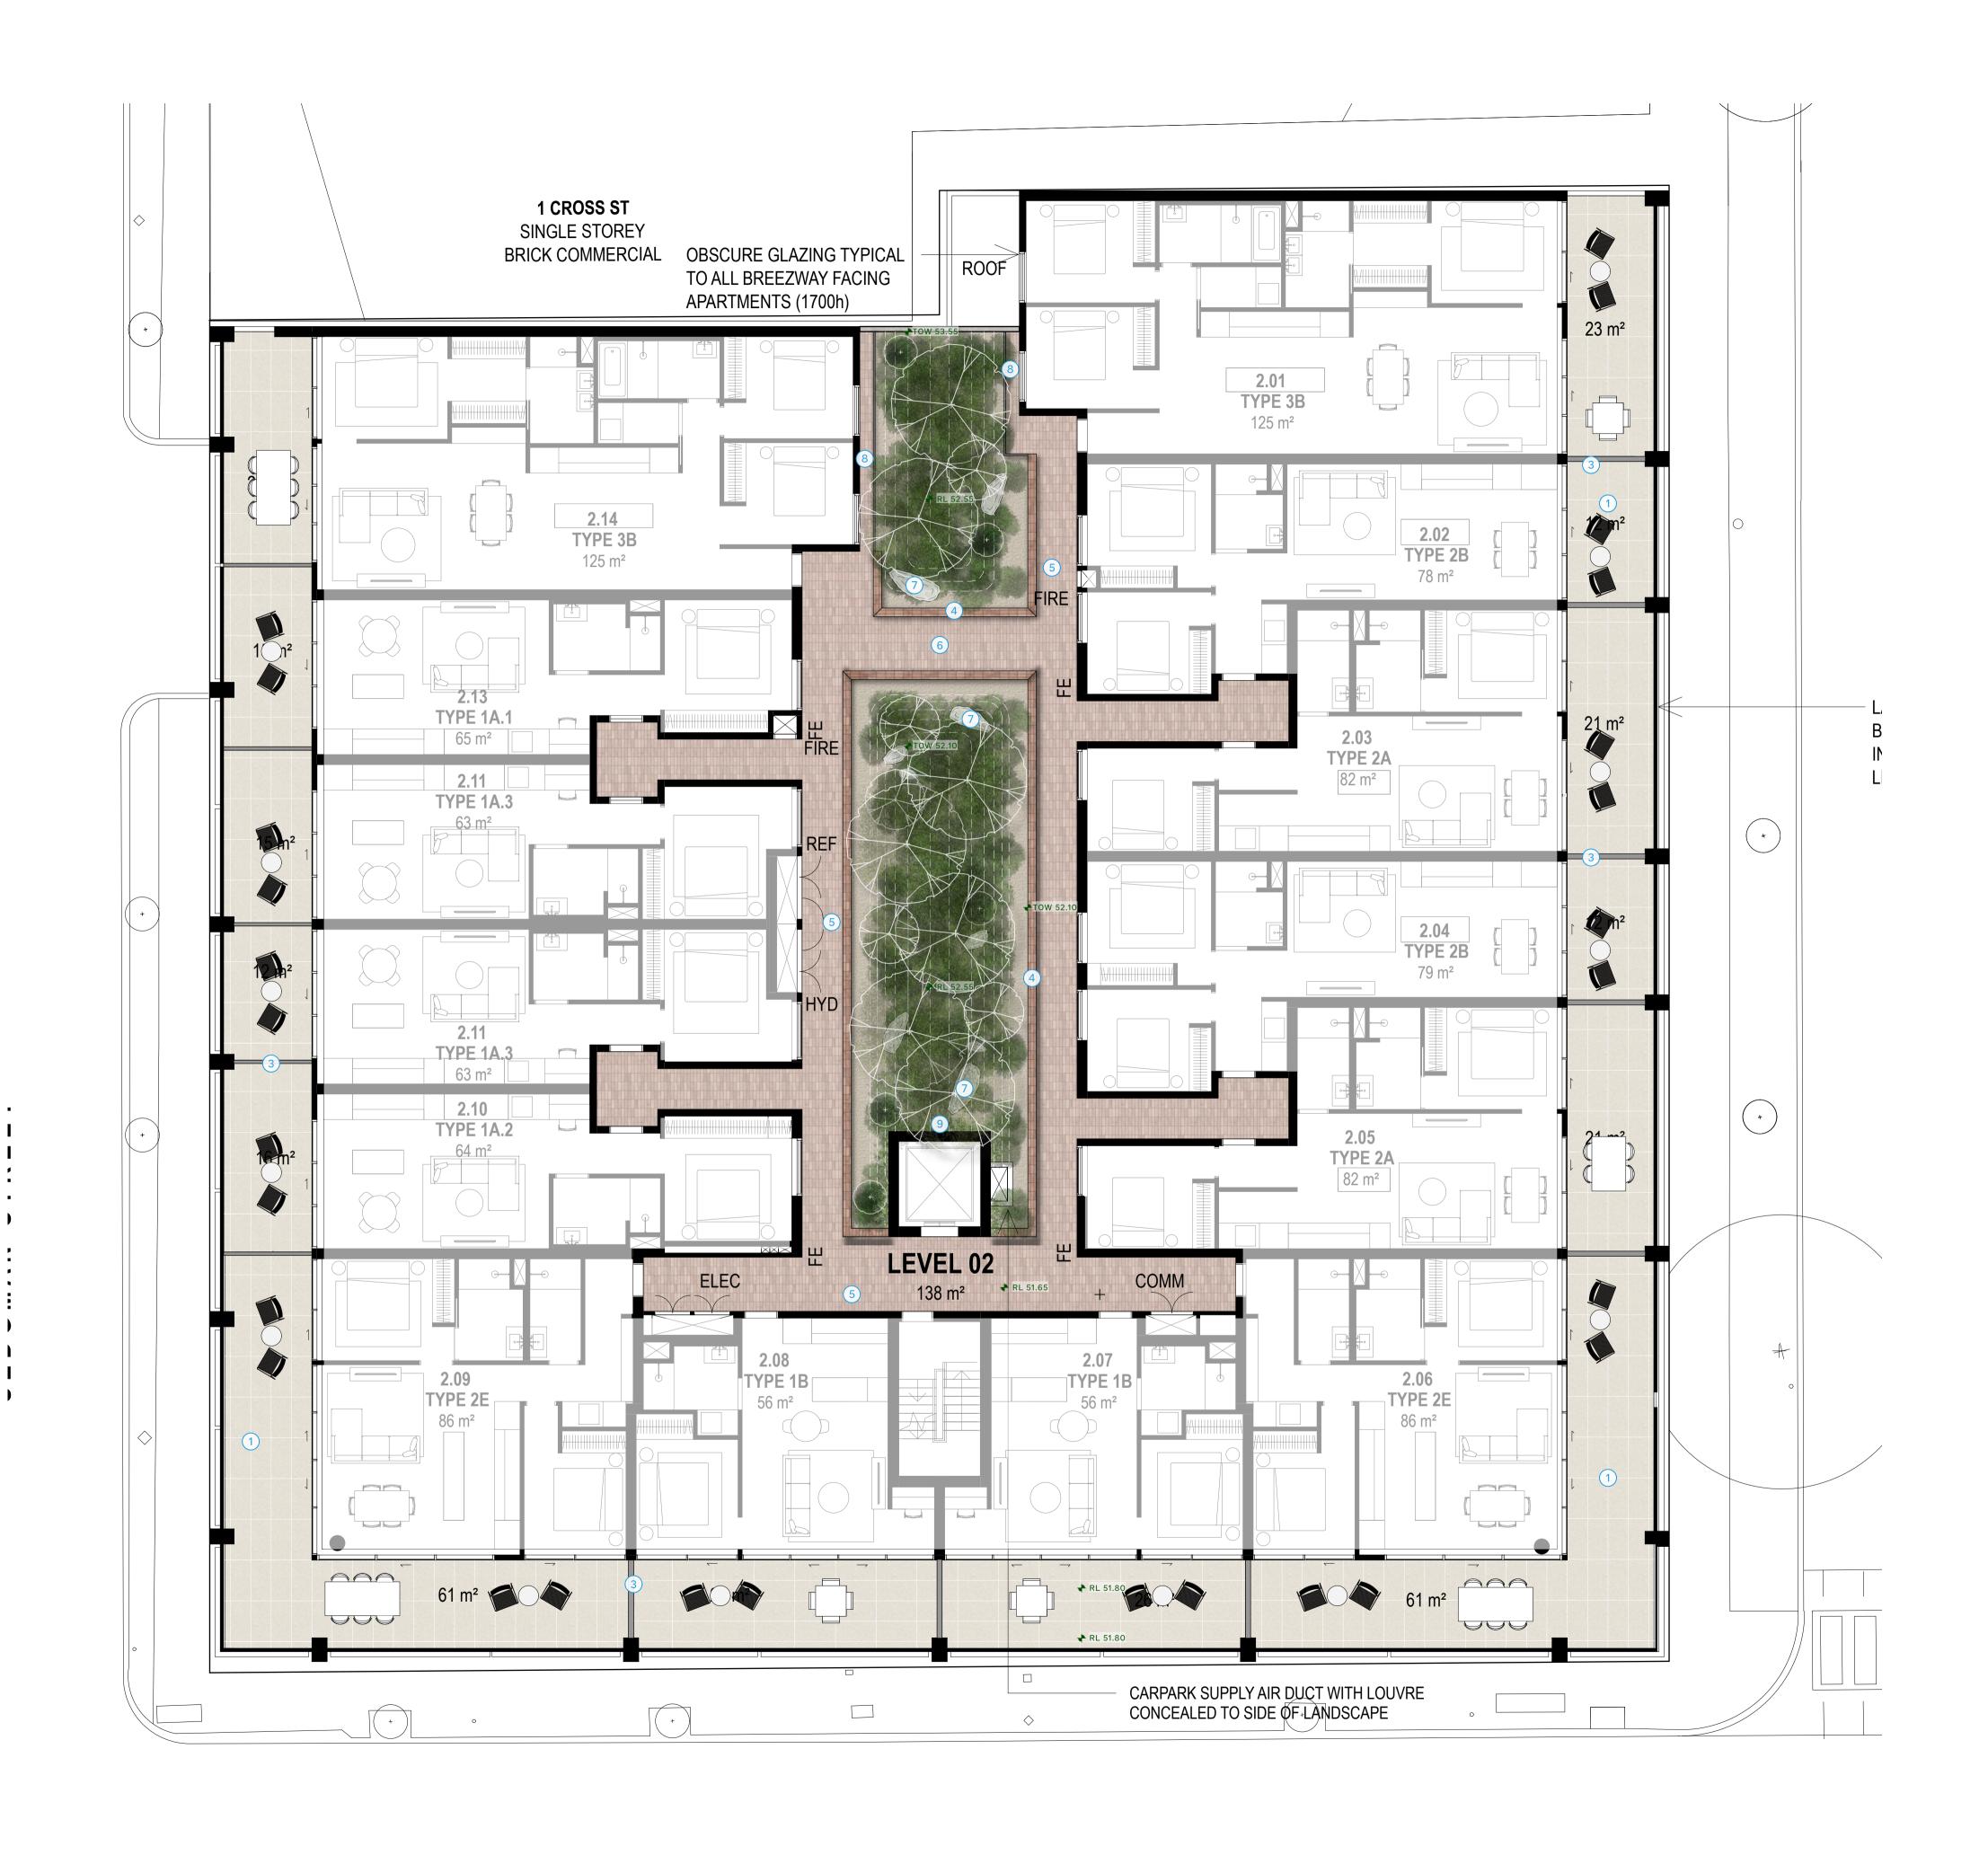

1 Landscape Plan - Level 2 Scale: 1:100

Sheet Title: Landscape Concept Plan - Level 2 Client: Neometro Address: 55 Albert St, Brunswick East Drawn by: WD Checked by: BR

Date: September 16, 2025 Revision: 4 Page Size: A1 Page: TP-2.03

Legend

CODE NOTE

Large Format Stone Pavers on Pedestal System.

Zero Threshold to Internal FFL

760mm High Perimeter Planters with Balustrade integrated

450mm High Planter to Courtyard incorporated with landscape mounding to tree planting

Climbers to create green verticallity to lift core

5 Small Format Pavers direct fixed to slab

3 1.7m High Privacy Screens

6 EGRESS Path

8 Service Path

7 Landscape Boulders

Acre



1 Landscape Plan - Level 3

Sheet Title: Landscape Concept Plan - Level 3 Date: Client: Neometro Address: 55 Albert St, Brunswick East Drawn by: WD Checked by: BR

Legend

CODE NOTE

Large Format Stone Pavers on Pedestal System.

Zero Threshold to Internal FFL

760mm High Perimeter Planters with Balustrade integrated


450mm High Planter to Courtyard incorporated with landscape mounding to tree planting

5 Small Format Pavers direct fixed to slab

3 1.7m High Privacy Screens

6 EGRESS Path - Gangway

Acre

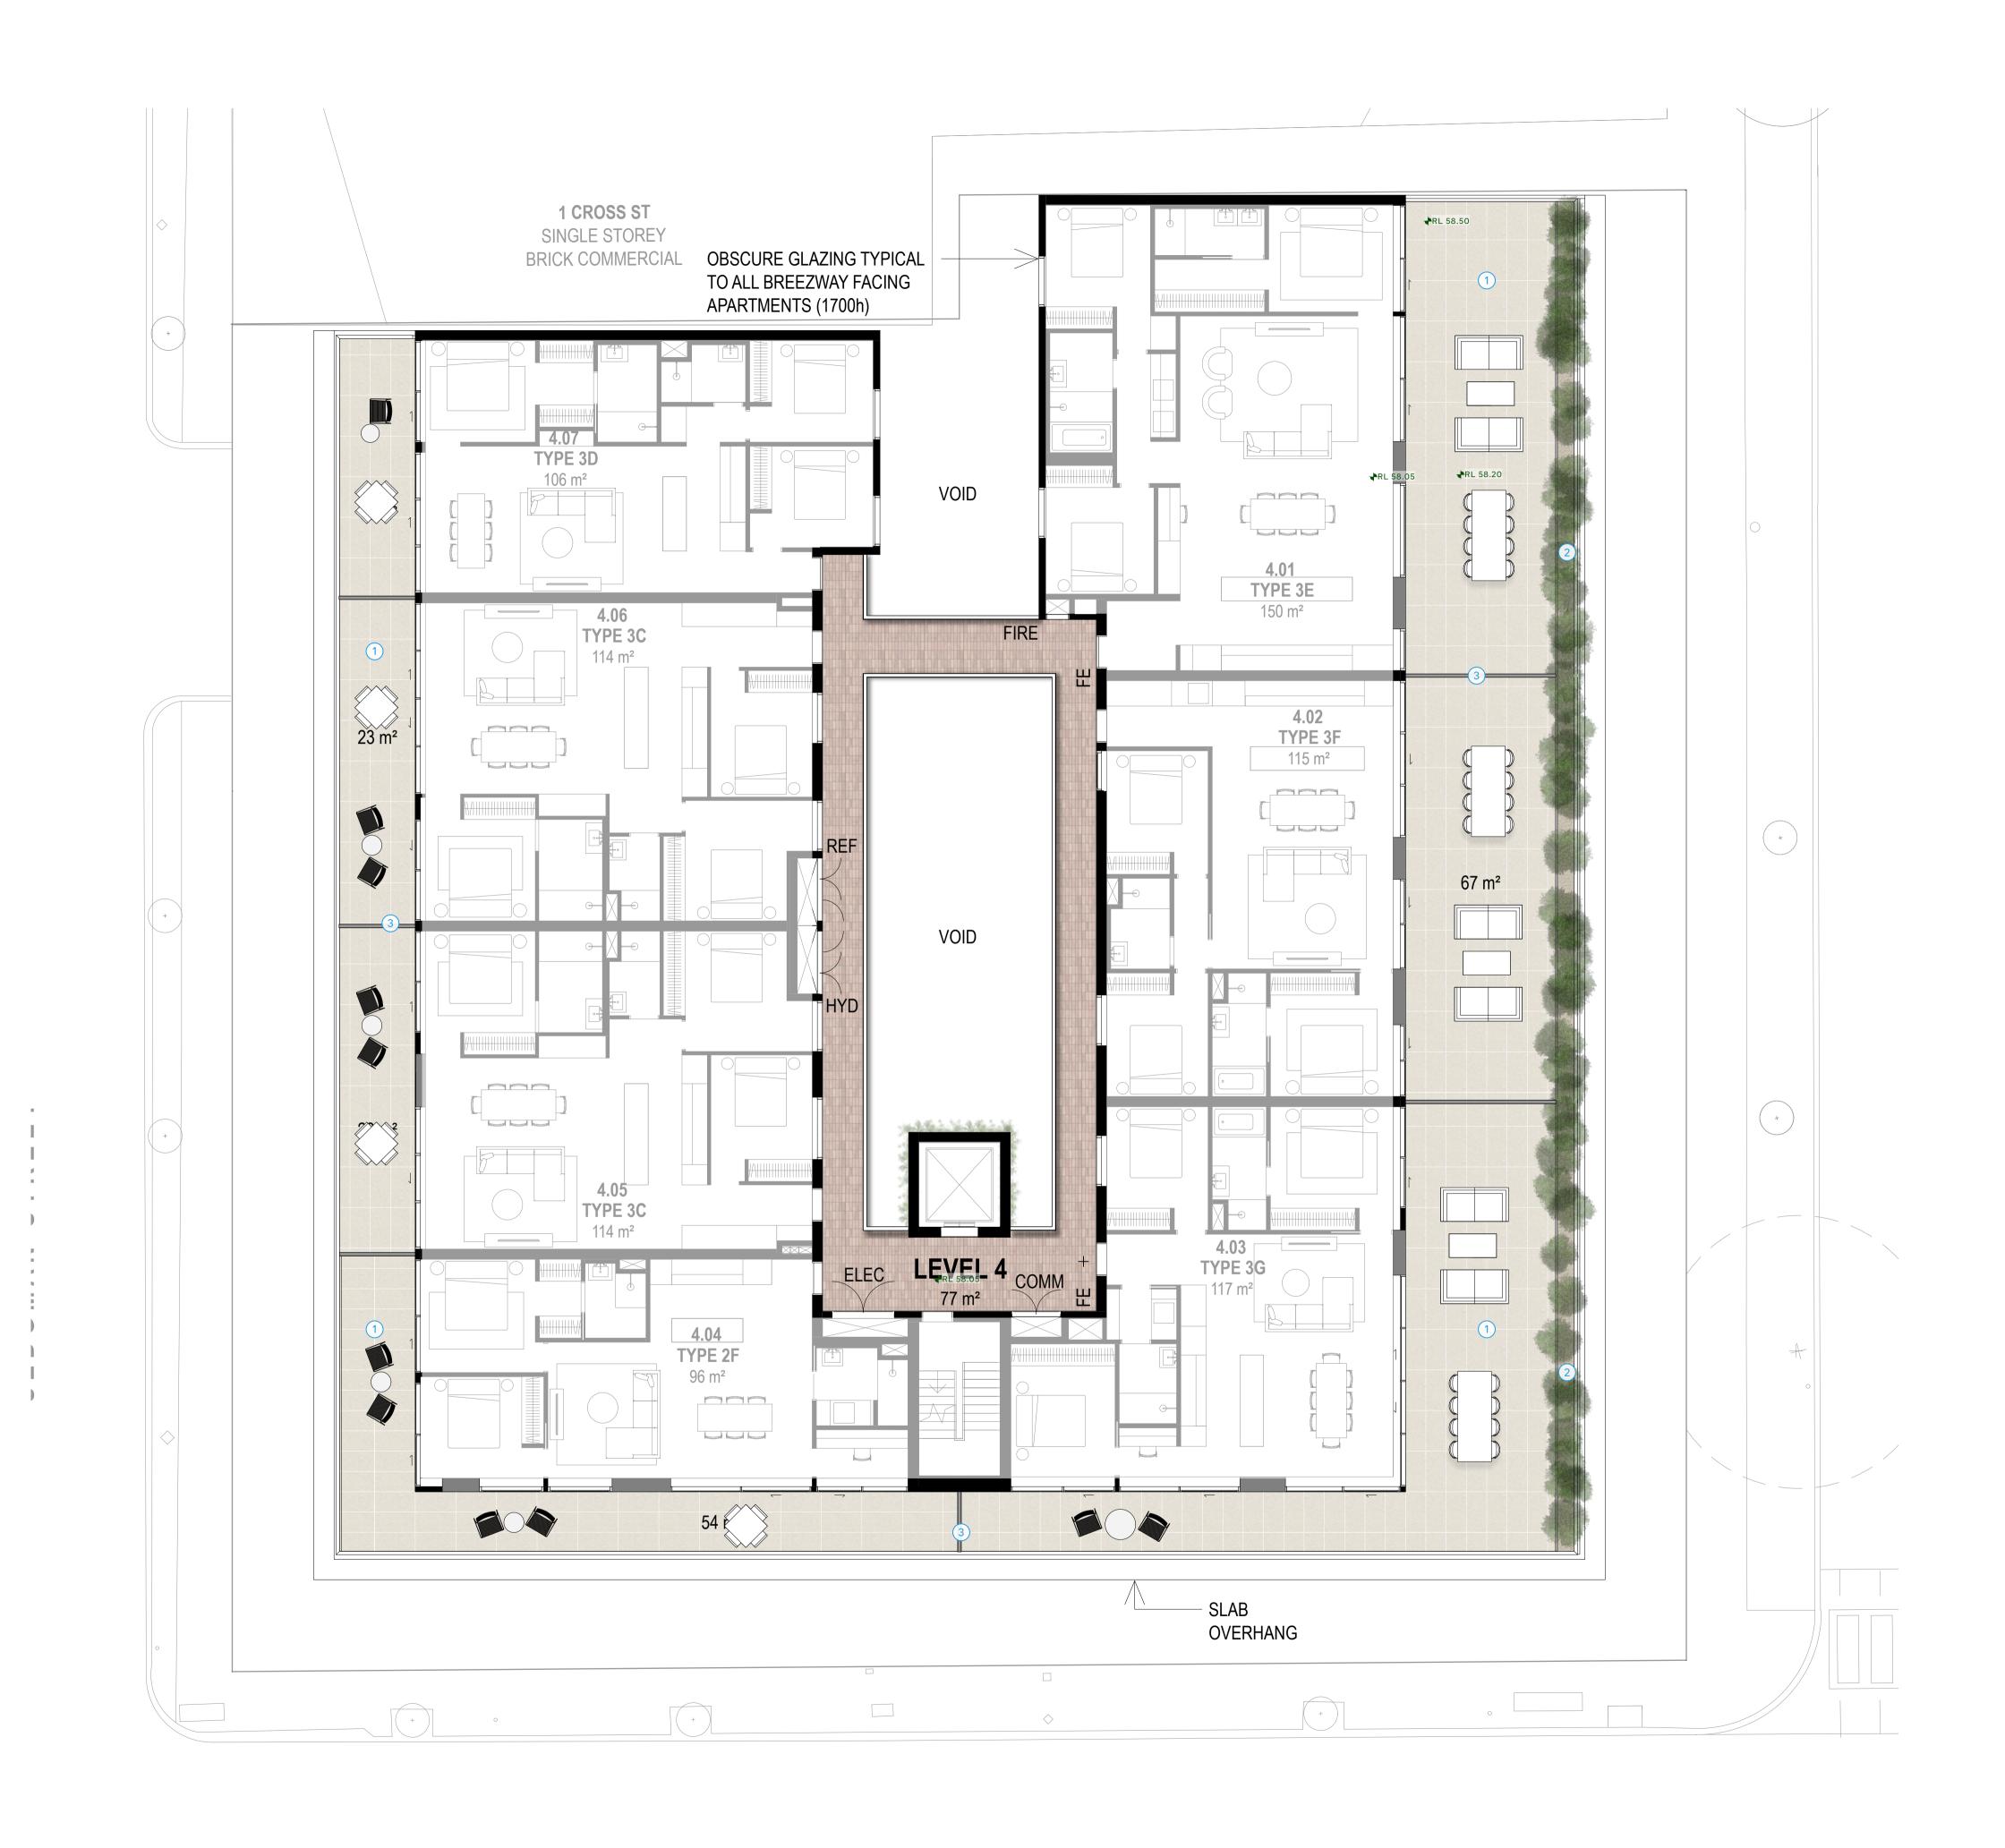

Legend CODE NOTE

Large Format Stone Pavers on Pedestal System.


Zero Threshold to Internal FFL

2 Low-raised Planters

3 1.7m High Privacy Screens

1 Landscape Plan - Level 4

Acre

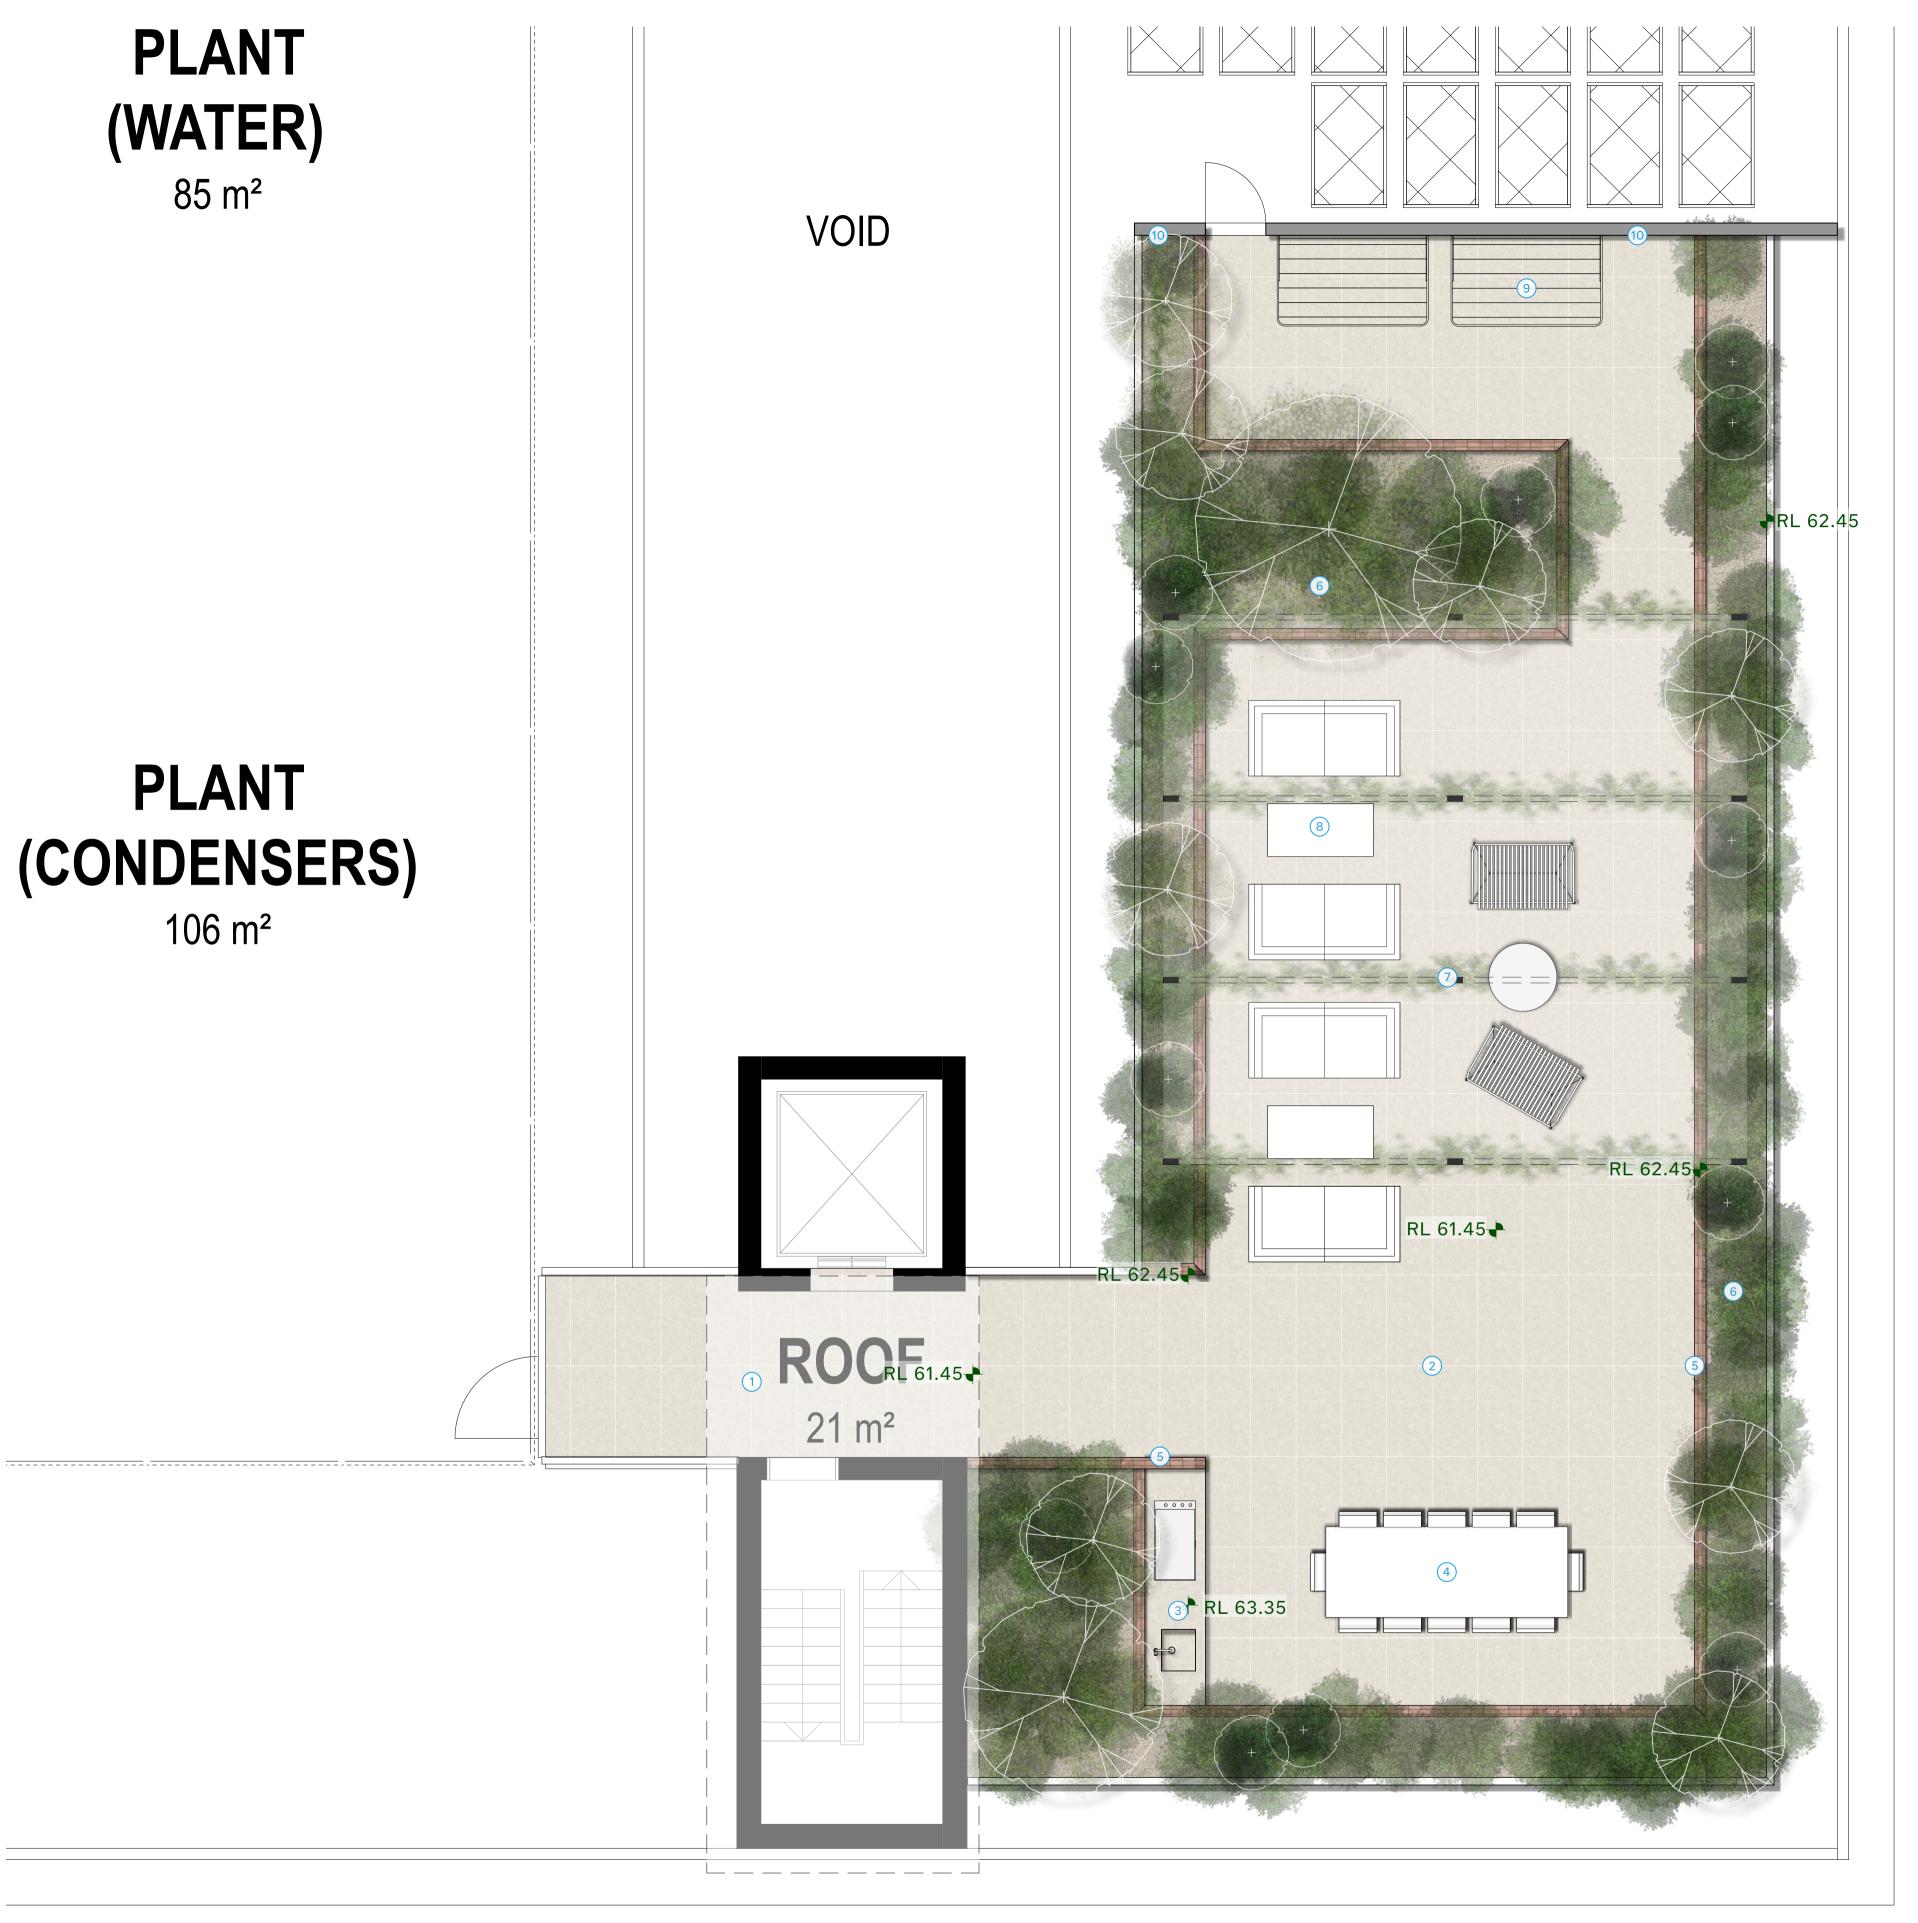

Landscape Plan - Roof Level

Sheet Title: Landscape Concept Plan - Roof Level Client: Neometro Address: 55 Albert St, Brunswick East Drawn by: WD Checked by: BR Legend

CODE NOTE

1 Canopy cover

3 BBQ Bench

(4) Communal Dining Area

6 1m high Raised Planter

9 Communal Clothlines


(7) Grating Pergola with Vine 8 Communal Gathering Space

2 Large-Format Stone Look Porcelain on Pedestal System

5 Brick to be internal Facets to Raised Planter

Screen with vine to add green verticality

Acre

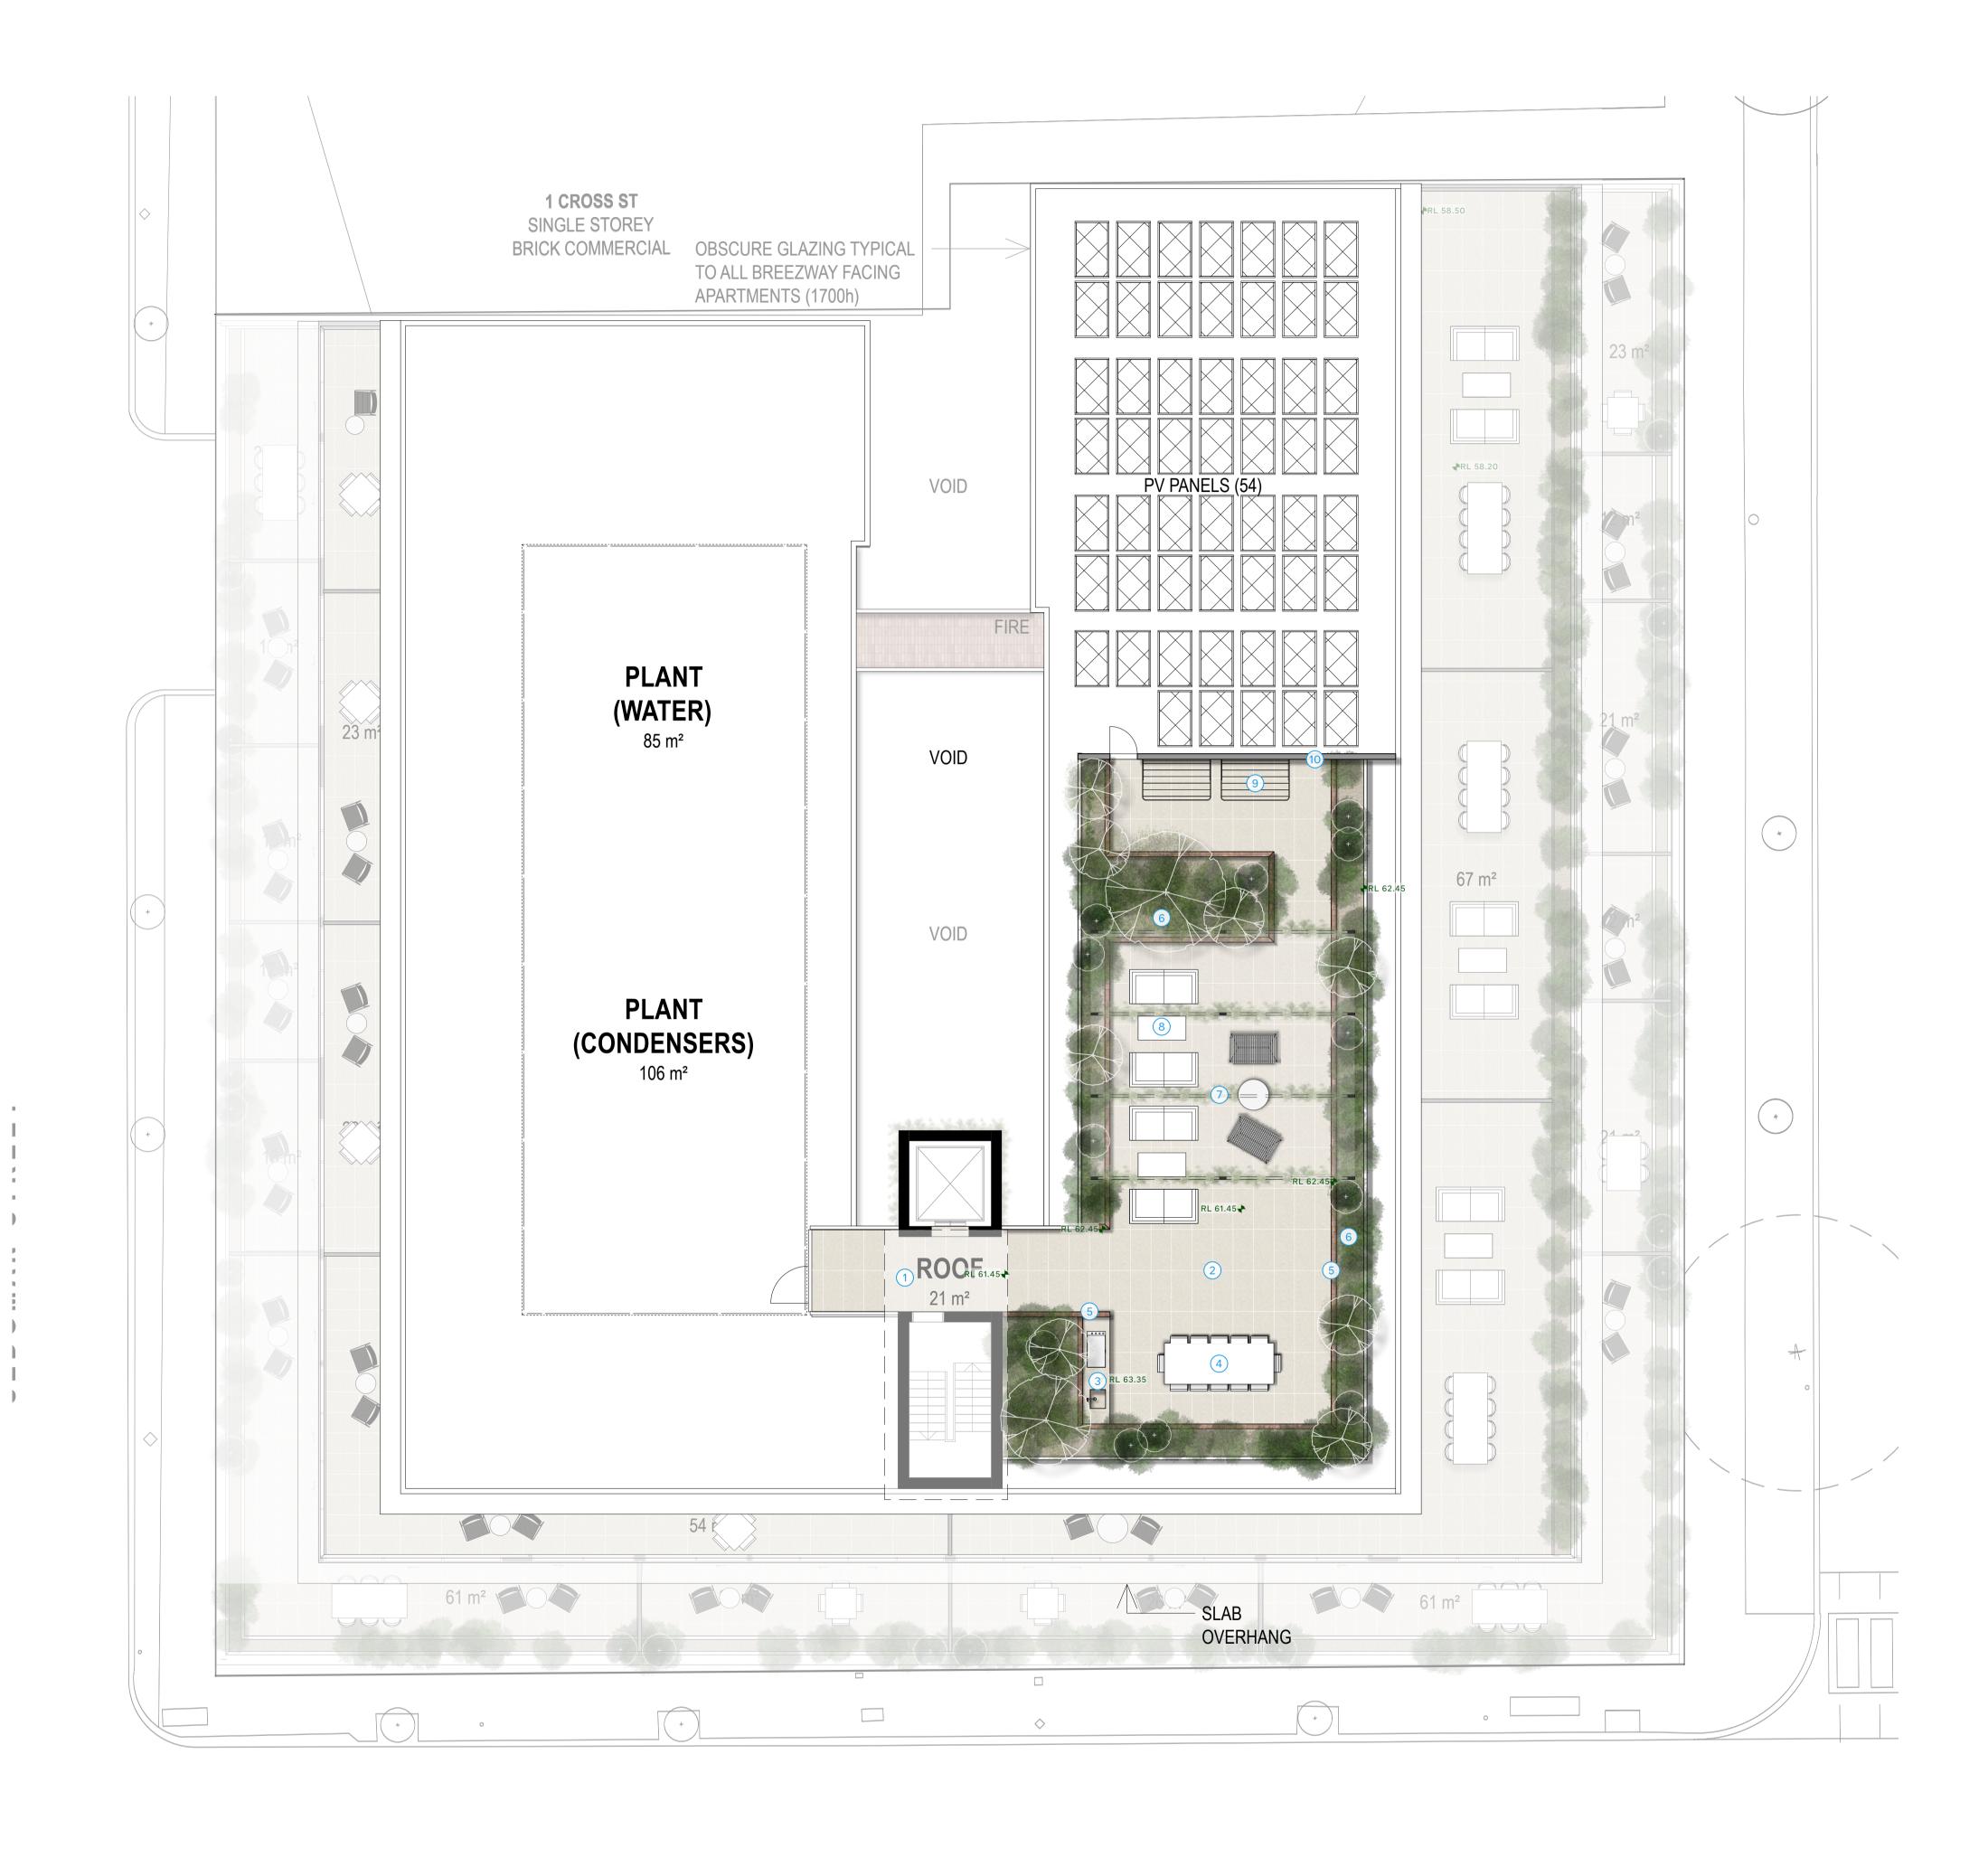

CODE NOTE

1 Canopy cover
2 Large-Format Stone Look Porcelain on Pedestal System
3 BBQ Bench
4 Communal Dining Area
5 Brick to be internal Facets to Raised Planter
6 1m high Raised Planter
7 Grating Pergola with Vine
8 Communal Gathering Space
9 Communal Clothlines

Screen with vine to add green verticality

1 Landscape Plan - Roof Level

September 16, 2025

Ref Image	Code	Description	Ref Image	Code	Description	Ref Image	Code	Description
	Cesi	Cedrella sinensis		AchH	Acacia howittii 'Honey Bun'		CagC	Casuarina glauca 'Cousin It'
	Cose	Cornus sericea		CajB	Camellia japonica 'Black Magic'		Coas	Correa alba 'star showers'
	PhmP	Philotheca myoporoides 'Profusion'		Drer	Dryopteris erythrosora		Doas	Doodia aspera
	LocM	Lomandra confertifolia ssp. rubiginosa mist		Muax	Muehlenbeckia axillaris		SccM	Scabiosa columbaria 'Merlot'
	Setm	Sedum telephium 'Matrona'		CirE	Cissus rhombifolia 'Ellen Danica'		Pahe	Parthenocissus henryana

Ref Image	Code	Description	Ref Image	Code	Description	Ref Image	Code	Description
	AchH	Acacia howittii 'Honey Bun'		AdcC	Adenanthos cuneatus 'Coral Drift'		Coas	Correa alba 'star showers'
	CocY	Cortinus coggygria 'Young Lady'		PhmP	Philotheca myoporoides 'Profusion'		RueT	Russelia equisetiformis 'Tangerine Falls'
	WefG	Westringia 'Grey Box'		AcmT	Achillea millefolium 'Terracotta		Setm	Sedum telephium 'Matrona'
	LocM	Lomandra confertifolia ssp. rubiginosa mist		LimE	Liriope muscari 'Emerald Falls'		Stgi	Stipa gigantea
	Coda	Cotoneaster dammeri		Grga	Grevillea gaudichaudii			

Ref Image	Code	Description	Ref Image	Code	Description	Ref Image	Code	Description
	Lear	Leucadendron argenteum		Cigl	Citrus glauca		CihR	Citrus hybrid 'Red Centre Lime'
	Cime	Citrus x meyeri		AchH	Acacia howittii 'Honey Bun'		LanB	Laurus nobilis 'Baby Bay'
	Leb	Leptospermum brachyandrum 'Jack Frost'		LesS	Leucadendron salignum 'Star Struck'		OrrD	Origanum 'Dingle Fairy'
	PhmP	Philotheca myoporoides 'Profusion'		Roof	Rosmarinus officinalis		Saof	Salvia officinalis
	WefG	Westringia 'Grey Box'		SccM	Scabiosa columbaria 'Merlot'		LocM	Lomandra confertifolia ssp. rubiginosa mist
	Stgi	Stipa gigantea		CagS	Casuarina glauca prostrate 'Shagpile'		Coda	Cotoneaster dammeri
	Grga	Grevillea gaudichaudii		Roop	Rosmarinus officinalis 'Prostratus		Thci	Thymus citriodorus

Acre

Albert Street

Sheet Title:	Plant Palette	Plant Palette - Rooftop					
Client:	Neometro	Neometro					
Address:	55 Albert St	55 Albert St, Brunswick East					
Drawn by:	WD	Checked by:	BR	P			

Date: September 16, 2025

Revision: 4

Page Size: A3

Page: TP-3.03



Planting Plan - Ground Level

Acre Architecture for Landscapes
3/4 Brown St. Collingwood VIC 3066 Aus
info@acre.com.au 03 7018 3135
acre.com.au @acre.landscape

Albert Street

These are conceptual drawings only. Acre Landscape Architecture Studio will not be held responsible for any structural works constructed from these drawings. All dimensions to be confirmed on site by contractor prior to commencement of works.

PLANT SCHEDULE - GROUND FLOOR

Shrubs CajB CoaS

PhmP

SetM

LocM

CagC

Muax

Pahe

Dre

Perennials SccM

Grasses/Strappy

Groundcovers

Succulents
Climbers
CirE

Ferns / Shade Perennials

QTY BOTANICAL NAME

4 Camellia japonica 'Black Magic'

10 Philotheca myoporoides 'Profusion'

64 Lomandra confertifolia ssp rubignosa 'Mist'

16 Correa alba 'Star Showers'

18 Scabiosa columbaria 'Merlot'

42 Sedum telephium 'Matrona'

24 Casuarina glauca 'Cousin It'

22 Cissus rhombifolia 'Ellen Danica'

30 Muehlenbeckia axillaris

6 Parthenocissus henryana

149 Dryopteris erythrosora

58 Doodia aspera

COMMON NAME

Native Fuchsia

Wax Flower

Ochroleuca

Sedum Matrona

Rubiginosa mist

Oak Leaf Ivy

Casuarina 'Cousin It'

Creeping Wire Vine

Silver Vein Creeper

Prickly rasp fern

Autumn fern

Black Magic Camellia

*HEIGHT

2 m

0.4 m

0.8 m

0.8 m

0.6 m

0.2 m

0.2 m

4 - 10 m

6 - 9 m

0.4 m

0.5 m

* = maintained

1 m

*SPREAD

1.5 m

1 m

0.8 m

0.5 m

0.4 m

0.6 m

1.5 m

CLIMBER

CLIMBER

0.5 m

0.5 m

1 m

SIZE

100 mm

300 mm

300 mm

140 mm

200 mm

200 mm

REMARKS


Sheet Title: Planting Plan-Ground Level			Date:	September 16, 2025	
Client:	Neometro			Revision:	4
ddress:	55 Albert St,	Brunswick East		Page Size:	A1
rawn by:	WD	Checked by:	BR	Page:	TP-3.04




ALBERT STREET

Planting Plan - Level 1
Scale: 1:100

Albert Street

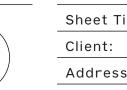

Sheet Title: Planting Plan-Level 1			Date:	September 16, 2025
Neometro			Revision:	4
55 Albert St, l	Brunswick East		Page Size:	A1
WD	Checked by:	BR	Page:	TP-3.05
	Neometro 55 Albert St, 1	Neometro 55 Albert St, Brunswick East	Neometro 55 Albert St, Brunswick East	NeometroRevision:55 Albert St, Brunswick EastPage Size:

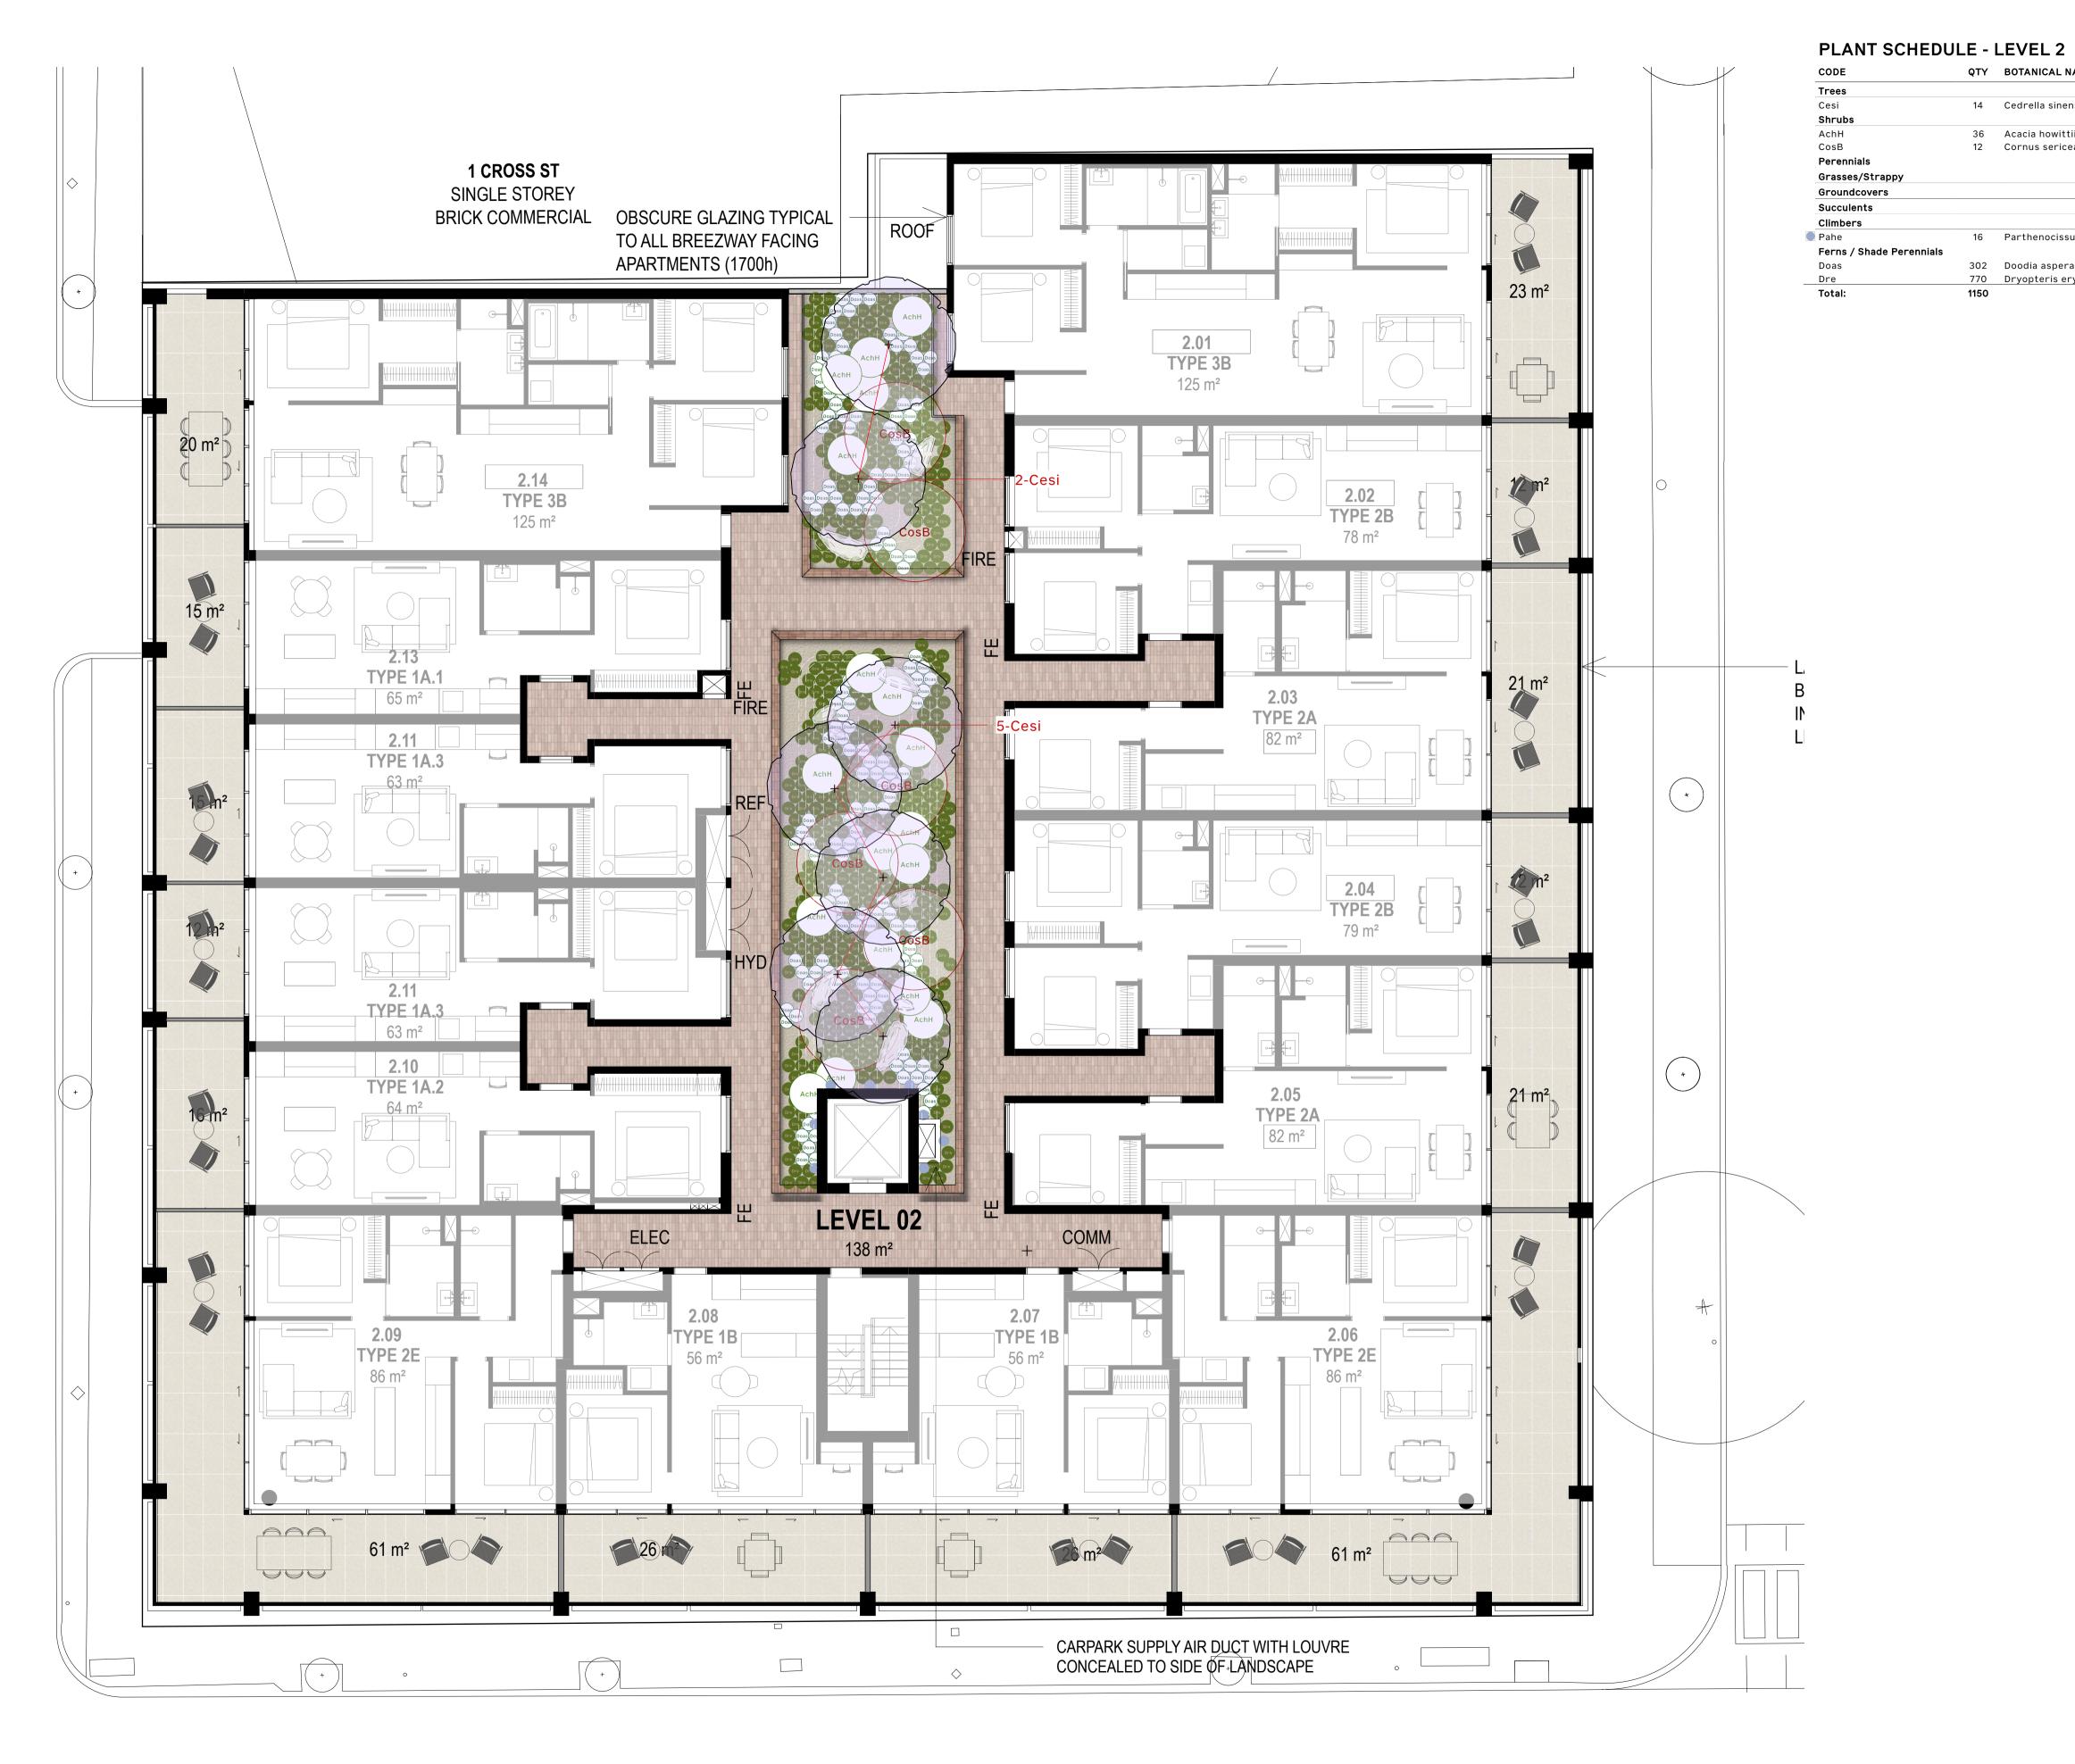

Planting Plan - Level 2
Scale: 1:100

Sheet Title: Planting Plan - Level 2 Date: September 16, 2025 Revision: 4 Client: Neometro Address: 55 Albert St, Brunswick East Page Size: A1 Drawn by: WD Checked by: BR Page: TP-3.06

QTY BOTANICAL NAME

14 Cedrella sinensis

36 Acacia howittii 'Honey Bun'

12 Cornus sericea f. Baileyi

16 Parthenocissus henryana

770 Dryopteris erythrosora

302 Doodia aspera

COMMON NAME

Chinese Cedar

Sticky wattle

Red Stem Cornus

Silver Vein Creeper

Prickly rasp fern

Autumn fern

*HEIGHT

1.2 m

6 - 9 m

0.5 m

* = maintained

0.4 m 0.5 m

3 m

*SPREAD

1.2 m

CLIMBER

0.5 m

3 m

SIZE

200 Ltr

300 mm

45L


140 mm

200 mm

200 mm

REMARKS

TYPE A

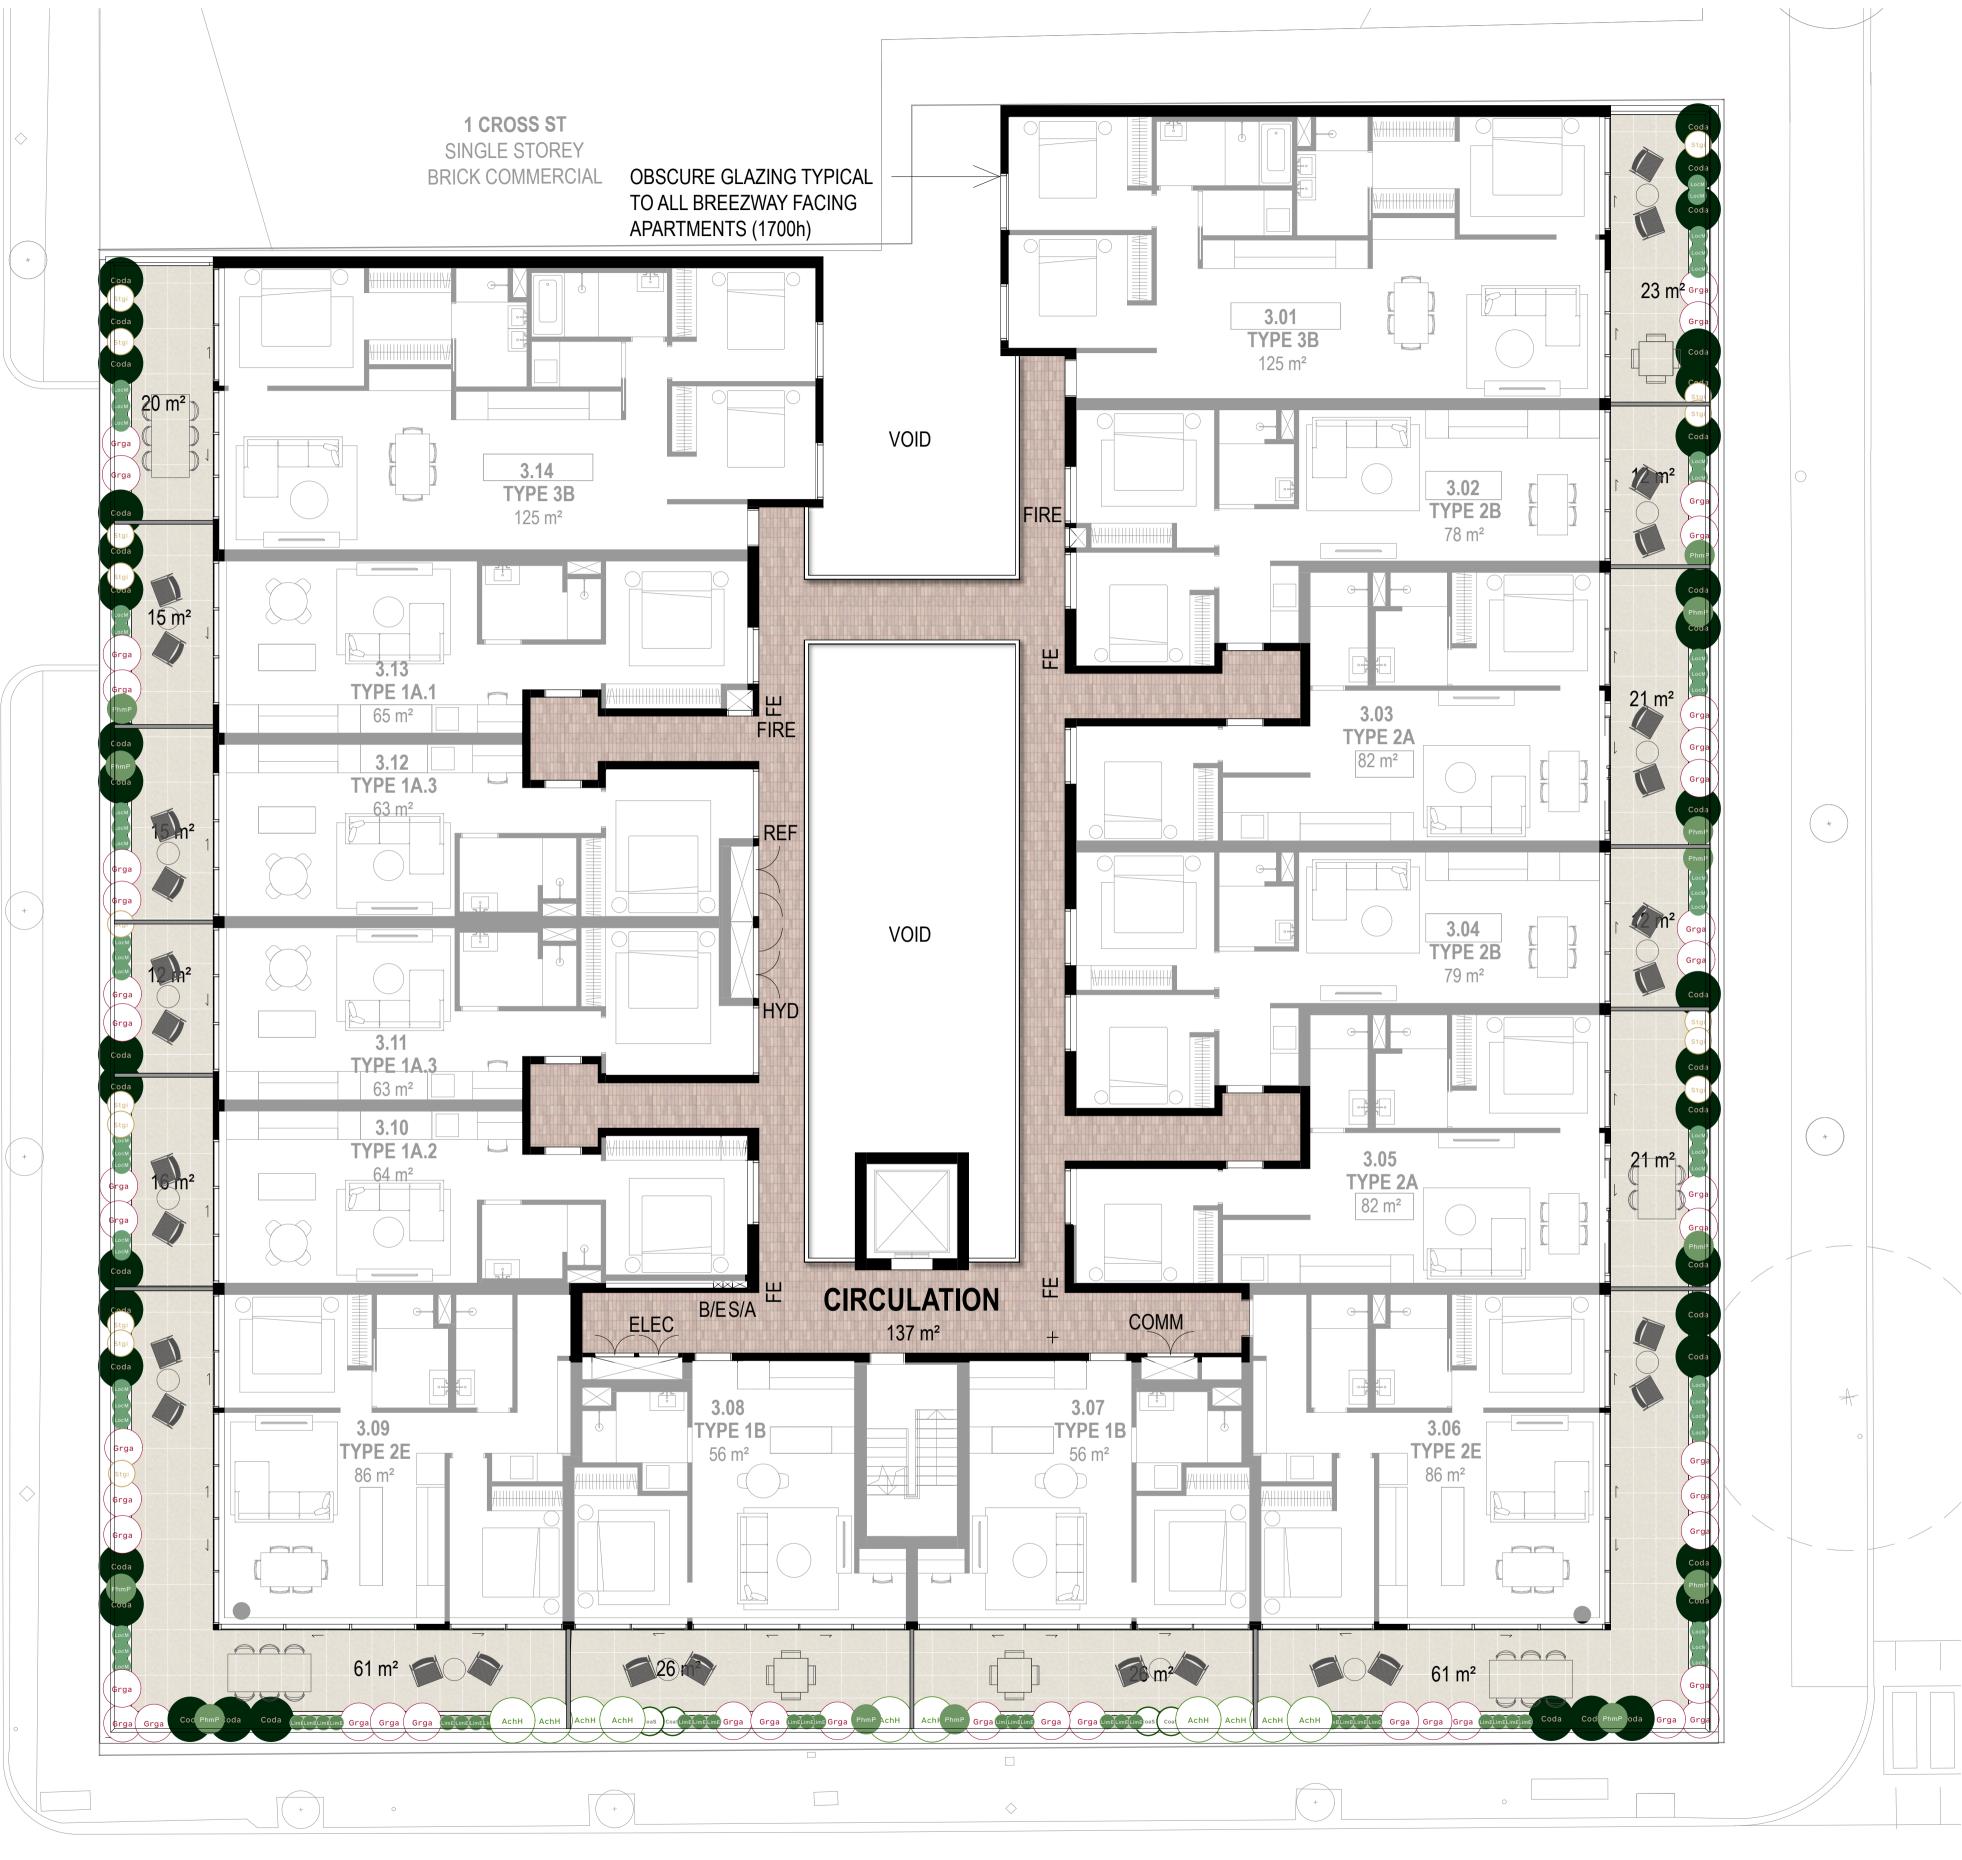

Planting Plan - Level 3
Scale: 1:100

Acre Architecture for Landscapes 3/4 Brown St. Collingwood VIC 3066 Aus info@acre.com.au 03 7018 3135 acre.com.au @acre.landscape

Albert Street


These are conceptual drawings only. Acre Landscape Architecture Studio will not be held responsible for any structural works constructed from these drawings. All dimensions to be confirmed on site by contractor prior to commencement of works.

Sheet Title: Planting Plan-Level 3			Date:	September 16, 2025	
Client:	Neometro			Revision:	4
Address:	55 Albert St,	Brunswick East		Page Size:	A1
Drawn by:	WD	Checked by:	BR	Page:	TP-3.07

CODE	QTY	BOTANICAL NAME	COMMON NAME	*HEIGHT	*SPREAD	SIZE	REMARKS
Trees							
Shrubs							
AchH	20	Acacia howittii 'Honey Bun'	Sticky wattle	1.2 m	1.2 m	300 mm	
CoaS	8	Correa alba 'Star Showers'	Native Fuchsia	0.4 m	1 m	300 mm	
PhmP	25	Philotheca myoporoides 'Profusion'	Wax Flower	0.8 m	0.8 m	300 mm	
Perennials							
Grasses/Strappy							
LimE	56	Liriope muscari 'Emerald Cascade'	Monkey Grass	0.4 m	0.4 m	200 mm	
LocM	90	Lomandra confertifolia ssp rubignosa 'Mist'	Rubiginosa mist	0.6 m	0.6 m	140 mm	
Stgi	32	Stipa gigantea	Feather Feather Grass	1.5 m	0.8 m	300 mm	
Groundcovers							
Coda	75	Cotoneaster dammeri	Bearberry Cotoneaster	0.4 m	1.8 m	200 mm	
Grga	90	Grevillea gaudichaudii	Groundcover Grevillea	0.3 m	1 m	140 mm	
Succulents							
Climbers							

* = maintained

Ferns / Shade Perennials

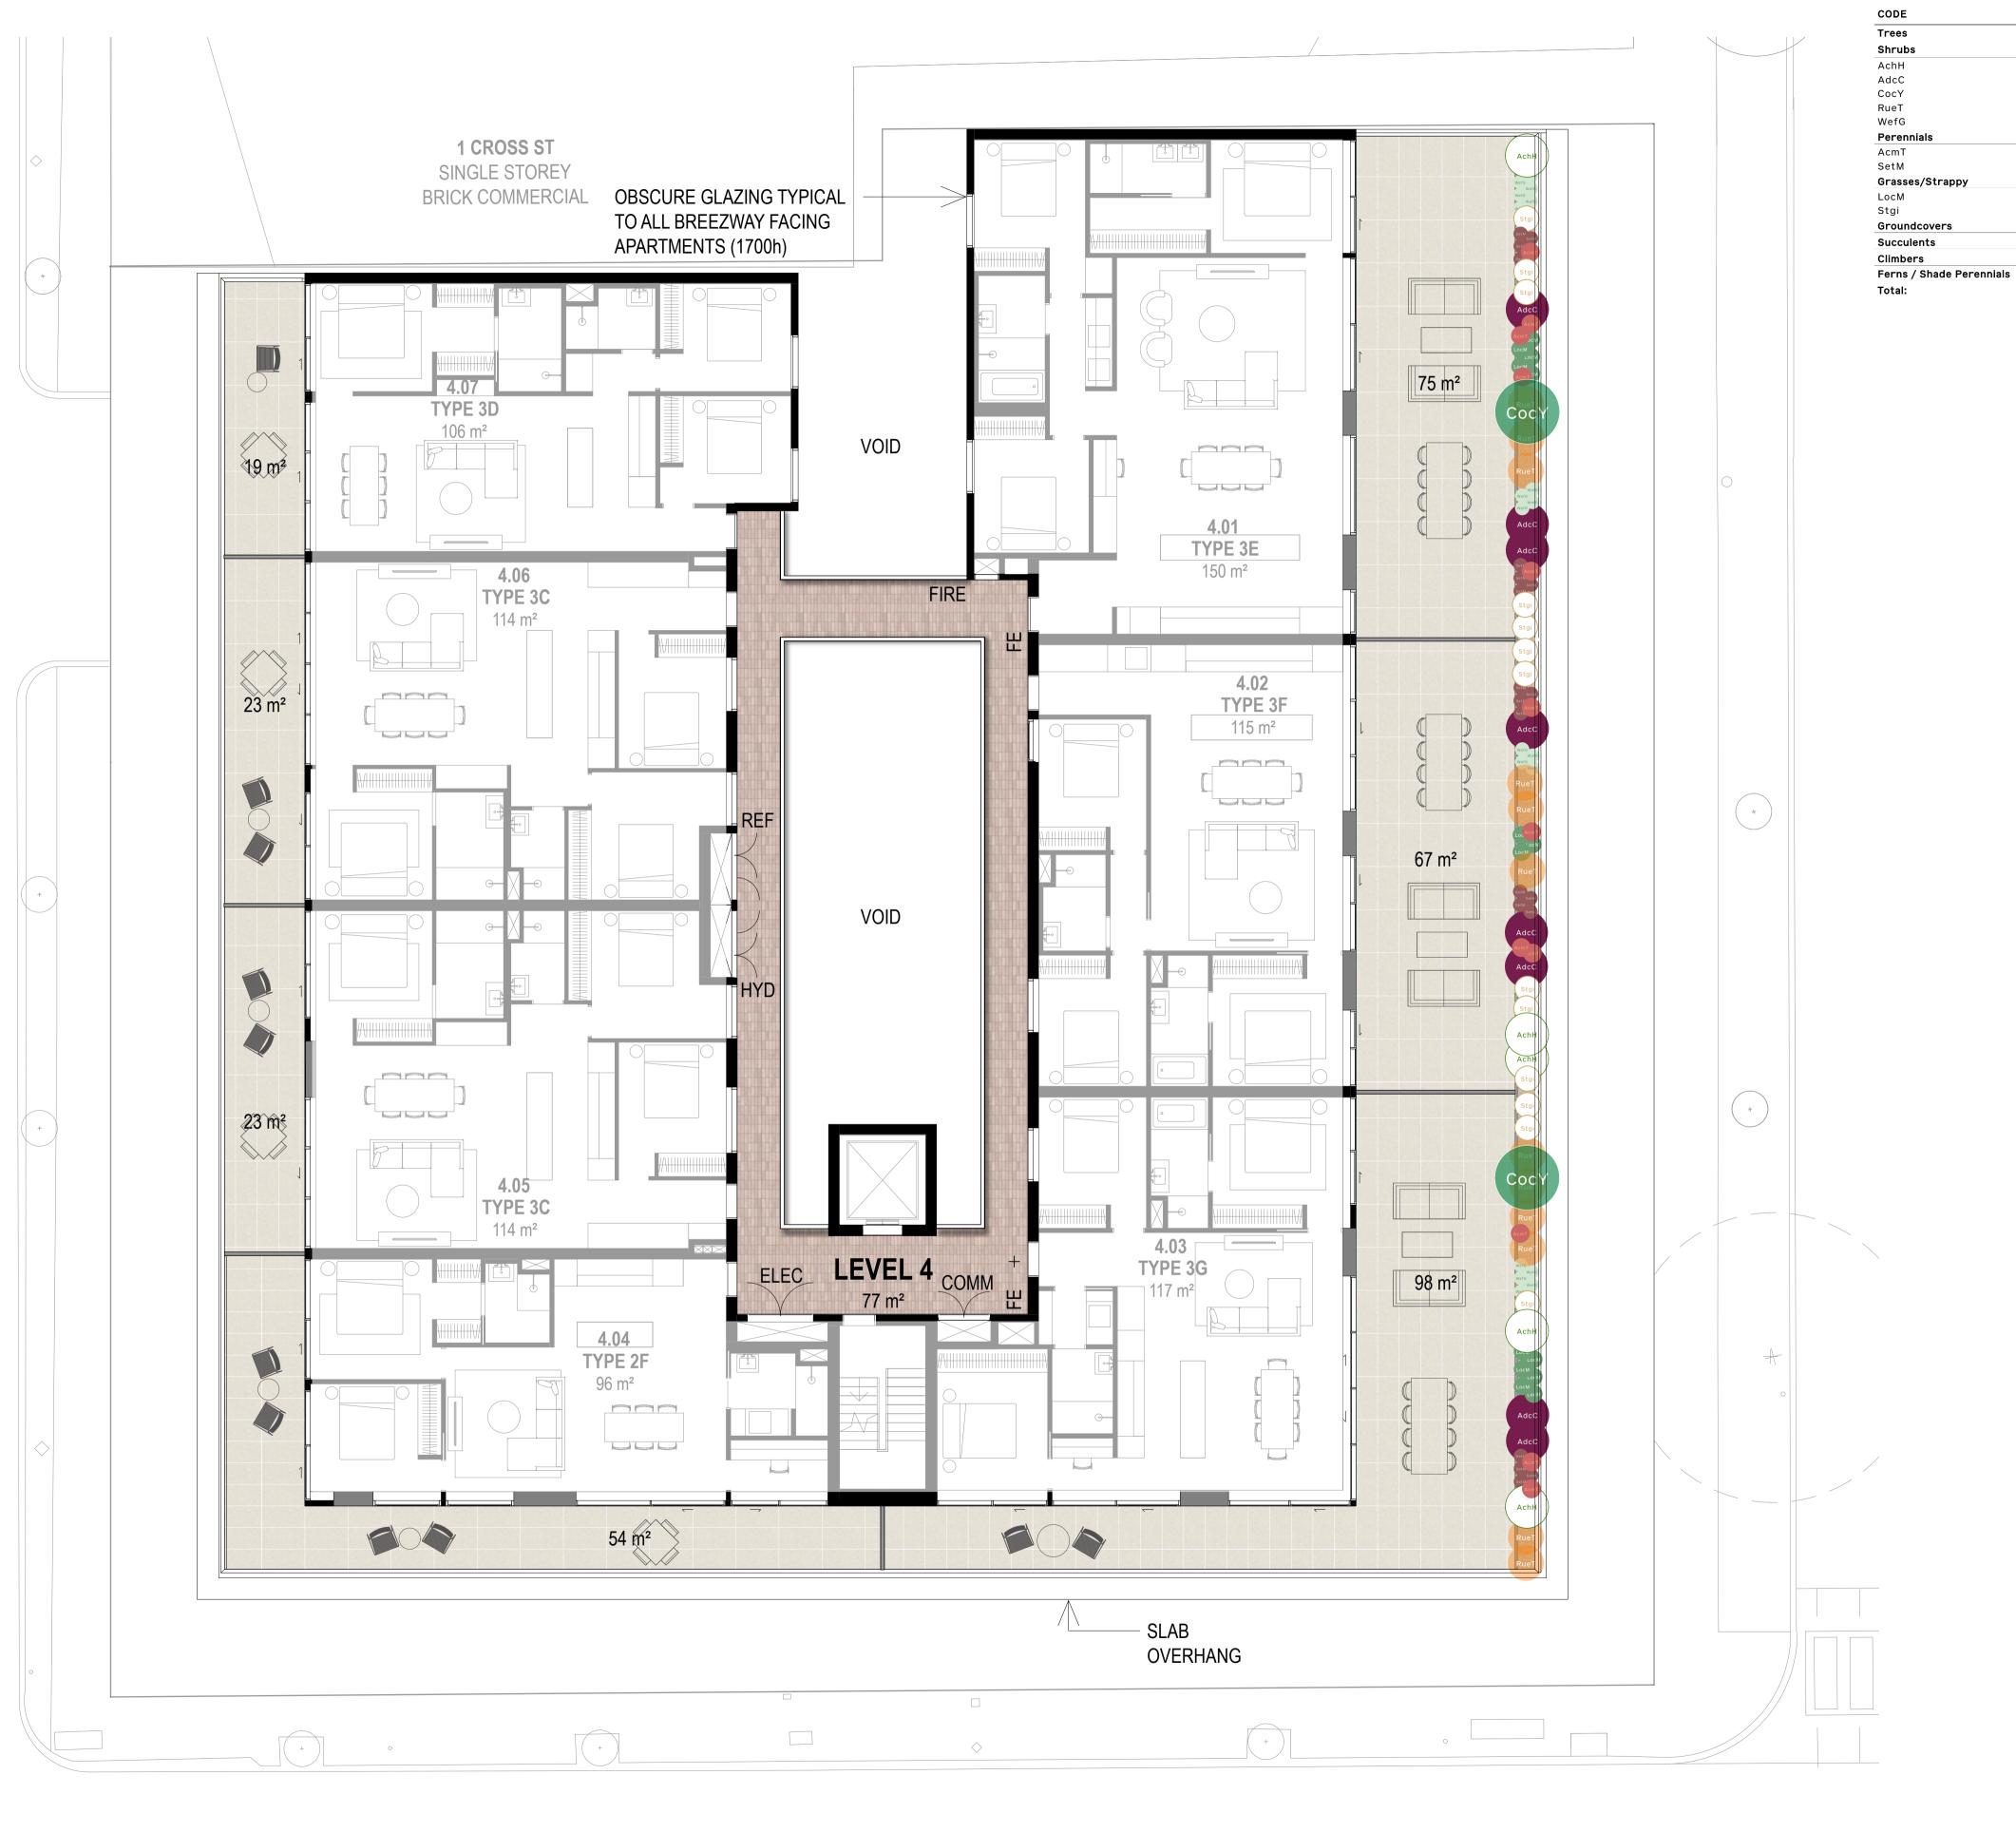

Planting Plan - Level 4
Scale: 1:100

acre.com.au @acre.landscape

Acre Architecture for Landscapes 3/4 Brown St. Collingwood VIC 3066 Aus info@acre.com.au 03 7018 3135

Albert Street

These are conceptual drawings only. Acre Landscape Architecture Studio will not be held responsible for any structural works constructed from these drawings. All dimensions to be confirmed on site by contractor prior to commencement of works.

PLANT SCHEDULE - LEVEL 4

QTY BOTANICAL NAME

10 Acacia howittii 'Honey Bun'

16 Adenanthos cuneatus 'Coral Drift'

38 Westringia fruticosa 'Grey Box'

24 Achillea millefolium 'Terracotta'

40 Sedum telephium 'Matrona'

26 Stipa gigantea

4 Cortinus coggygria 'Young Lady'24 Russelia equisetiformis 'Tangerine Falls'

28 Lomandra confertifolia ssp rubignosa 'Mist'

COMMON NAME

Sticky wattle

Coral Drift

Smoke bush

Firecracker Plant

Native Rosemary

Sedum Matrona

Rubiginosa mist

Feather Feather Grass

Achillea Terracotta

*HEIGHT *SPREAD

1.2 m

1.5 m

2.0 m

0.4 m

0.5 m

0.4 m

0.6 m

0.8 m

1 m

1.2 m

0.3 m

2.0 m

1 m

0.4 m

0.8 m

0.6 m

* = maintained

1.5 m

1 m

SIZE

300 mm

300 mm

300 mm

300 mm

300 mm

140 mm


140 mm

140 mm

300 mm

REMARKS

Sheet Title: Planting Plan - Level 4				Date:	September 16, 2025
Client:	Neometro			Revision:	4
Address:	55 Albert St,	Brunswick East		Page Size:	A1
Drawn by:	WD	Checked by:	BR	Page:	TP-3.08

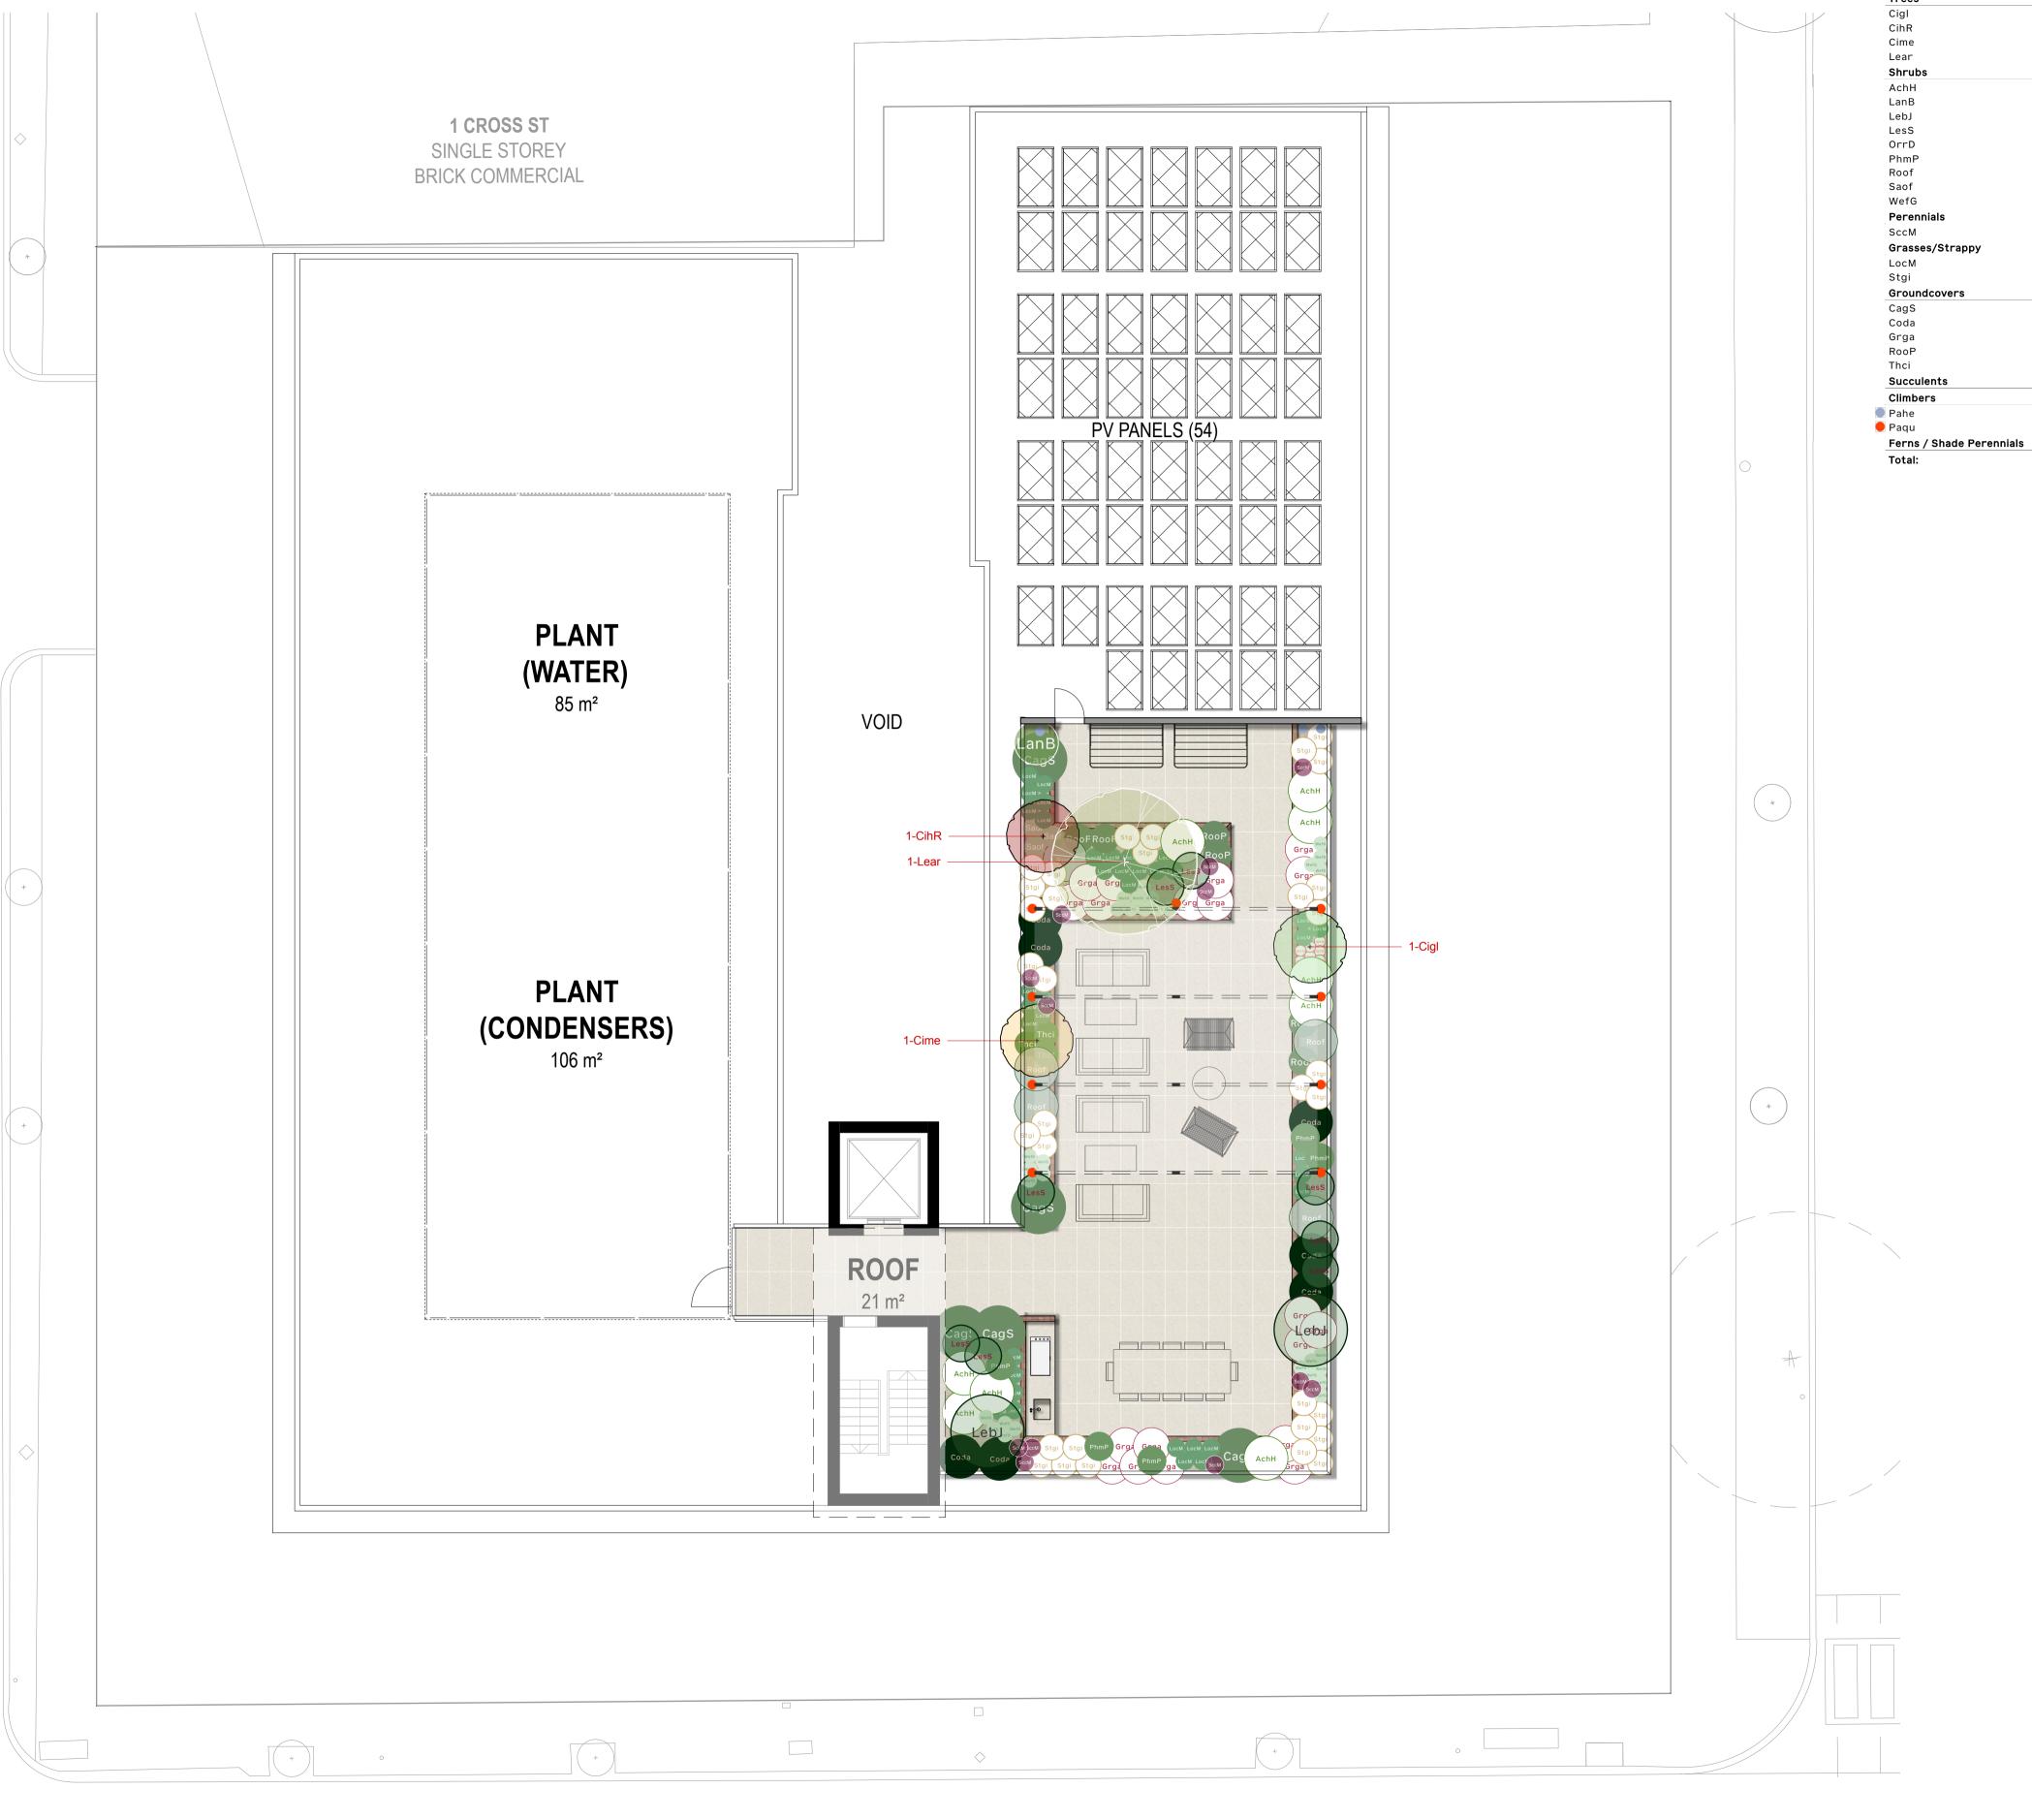

Planting Plan - Roof Level

3/4 Brown St. Collingwood VIC 3066 Aus info@acre.com.au 03 7018 3135 acre.com.au @acre.landscape

Architecture for Landscapes

Acre

Albert Street

These are conceptual drawings only. Acre Landscape Architecture Studio will not be held responsible for any structural works constructed from these drawings. All dimensions to be confirmed on site by contractor prior to commencement of works.

PLANT SCHEDULE - ROOF LEVEL

CODE	QTY	BOTANICAL NAME	COMMON NAME	*HEIGHT	*SPREAD	SIZE	REMARKS
Trees							
Cigl	2	Citrus glauca	Desert Lime	3 m	2 m	45 Ltr	
CihR	2	Citrus hybrid 'Red Centre Lime'	Red Centre Lime	2.5 m	2 m	45 Ltr	
Cime	2	Citrus x meyeri	Myer Lemon	3 m	2 m	45 Ltr	
Lear	2	Leucadendron argenteum	Leucadendron Silver Tree	7 m	4 m	100 Ltr	TYPE A
Shrubs							
AchH	18	Acacia howittii 'Honey Bun'	Sticky wattle	1.2 m	1.2 m	300 mm	
LanB	2	Laurus nobilis 'Baby Bay'	Dwarf Bay Tree	2 m	2 m	300 mm	Edible
LebJ	4	Leptospermum brachyandrum 'Jack Frost'	Silver Weeping Tea Tree	3 m	2 m	300 mm	
LesS	16	Leucadendron salignum 'Star Struck'	Leucadendron 'Star Struck'	1 m	1 m	300 mm	
OrrD	14	Origanum rotundifolium 'Dingle Fairy'	Dingle Fairy	0.15 m	0.30 m	300 mm	
PhmP	10	Philotheca myoporoides 'Profusion'	Wax Flower	0.8 m	0.8 m	300 mm	
Roof	10	Rosmarinus officinalis	Rosemary	1.4 m	1.2 m	300 mm	Edible
Saof	6	Salvia officinalis	Common Sage	0.6 m	0.6 m	300 mm	Edible
WefG	60	Westringia fruticosa 'Grey Box'	Native Rosemary	0.4 m	0.4 m	300 mm	
Perennials							
SccM	24	Scabiosa columbaria 'Merlot'	Ochroleuca	0.8 m	0.5 m	140 mm	
Grasses/Strappy							
LocM	74	Lomandra confertifolia ssp rubignosa 'Mist'	Rubiginosa mist	0.6 m	0.6 m	140 mm	
Stgi	66	Stipa gigantea	Feather Feather Grass	1.5 m	0.8 m	300 mm	
Groundcovers							
CagS	10	Casuarina glauca prostrate 'Shagpile'	She Oak	0.2 m	1.5 m	200 mm	
Coda	14	Cotoneaster dammeri	Bearberry Cotoneaster	0.4 m	1.8 m	200 mm	
Grga	38	Grevillea gaudichaudii	Groundcover Grevillea	0.3 m	1 m	140 mm	
RooP	12	Rosmarinus officinalis 'Prostratus	Prostrate Rosemary	0.2 m	1 m	200 mm	
Thci	6	Thymus citriodorus	Lemon Thyme	0.3 m	1 m	140 mm	Edible
Succulents			-				
Climbers							
Pahe	6	Parthenocissus henryana	Silver Vein Creeper	6 - 9 m	CLIMBER	140 mm	
Paqu	18	Parthenocissus quinquefolia	Virginia creeper	10 - 15 m	10 - 15 m	140 mm	

* = maintained

)		

eet Title: Planting Plan - Roof Level				Date:	September 16, 2025		
ient:	Neometro			Revision:	4		
ddress:	55 Albert St, Brunswick East			Page Size:	A1		
awn by:	WD	Checked by:	BR	Page:	TP-3.09		

PLANT SCHEDULE - TOTAL

CODE	QTY	BOTANICAL NAME	COMMON NAME	*HEIGHT	*SPREAD	SIZE	REMARKS
Trees							
Cesi	14	Cedrella sinensis	Chinese Cedar	8 m	4 m	200 Ltr	TYPE A
Cigl	2	Citrus glauca	Desert Lime	3 m	2 m	45 Ltr	
CihR	2	Citrus hybrid 'Red Centre Lime'	Red Centre Lime	2.5 m	2 m	45 Ltr	
Cime	2	Citrus x meyeri	Myer Lemon	3 m	2 m	45 Ltr	
Lear	2	Leucadendron argenteum	Leucadendron Silver Tree	7 m	4 m	100 Ltr	TYPE A
Shrubs		-					
AchH	84	Acacia howittii 'Honey Bun'	Sticky wattle	1.2 m	1.2 m	300 mm	
AdcC	16	Adenanthos cuneatus 'Coral Drift'	Coral Drift	0.3 m	1.5 m	300 mm	
CajB	4	Camellia japonica 'Black Magic'	Black Magic Camellia	2 m	1.5 m	100 mm	
CoaS	24	Correa alba 'Star Showers'	Native Fuchsia	0.4 m	1 m	300 mm	
CocY	4	Cortinus coggygria 'Young Lady'	Smoke bush	2.0 m	2.0 m	300 mm	
CosB	12	Cornus sericea f. Baileyi	Red Stem Cornus	3 m	3 m	45L	
LanB	2	Laurus nobilis 'Baby Bay'	Dwarf Bay Tree	2 m	2 m	300 mm	Edible
LebJ	4	Leptospermum brachyandrum 'Jack Frost'	Silver Weeping Tea Tree	3 m	2 m	300 mm	
LesS	16	Leucadendron salignum 'Star Struck'	Leucadendron 'Star Struck'	1 m	1 m	300 mm	
OrrD	14	Origanum rotundifolium 'Dingle Fairy'	Dingle Fairy	0.15 m	0.30 m	300 mm	
PhmP	45	Philotheca myoporoides 'Profusion'	Wax Flower	0.8 m	0.8 m	300 mm	
Roof	10	Rosmarinus officinalis	Rosemary	1.4 m	1.2 m	300 mm	Edible
RueT	24	Russelia equisetiformis 'Tangerine Falls'	Firecracker Plant	1 m	1 m	300 mm	
Saof	6	Salvia officinalis	Common Sage	0.6 m	0.6 m	300 mm	Edible
WefG	98	Westringia fruticosa 'Grey Box'	Native Rosemary	0.4 m	0.4 m	300 mm	
Perennials		3 · · · · · · · · · · · · · · · · · · ·	•				
AcmT	24	Achillea millefolium 'Terracotta'	Achillea Terracotta	0.8 m	0.5 m	140 mm	
SccM	42	Scabiosa columbaria 'Merlot'	Ochroleuca	0.8 m	0.5 m	140 mm	
SetM	82	Sedum telephium 'Matrona'	Sedum Matrona	1 m	0.4 m	140 mm	
Grasses/Strappy		·					
LimE	56	Liriope muscari 'Emerald Cascade'	Monkey Grass	0.4 m	0.4 m	200 mm	
LocM	256	Lomandra confertifolia ssp rubignosa 'Mist'	Rubiginosa mist	0.6 m	0.6 m	140 mm	
Stgi	124	Stipa gigantea	Feather Feather Grass	1.5 m	0.8 m	300 mm	
Groundcovers							
CagC	24	Casuarina glauca 'Cousin It'	Casuarina 'Cousin It'	0.2 m	1.5 m	140 mm	
CagS	10	Casuarina glauca prostrate 'Shagpile'	She Oak	0.2 m	1.5 m	200 mm	
Coda	89	Cotoneaster dammeri	Bearberry Cotoneaster	0.4 m	1.8 m	200 mm	
Grga	128	Grevillea gaudichaudii	Groundcover Grevillea	0.3 m	1 m	140 mm	
Muax	30	Muehlenbeckia axillaris	Creeping Wire Vine	0.2 m	1 m	140 mm	
RooP	12	Rosmarinus officinalis 'Prostratus	Prostrate Rosemary	0.2 m	1 m	200 mm	
Thci	6	Thymus citriodorus	Lemon Thyme	0.3 m	1 m	140 mm	Edible
Succulents		•	,				
Climbers							
CirE	22	Cissus rhombifolia 'Ellen Danica'	Oak Leaf Ivy	4 - 10 m	CLIMBER	140 mm	
Pahe	28	Parthenocissus henryana	Silver Vein Creeper	6 - 9 m	CLIMBER	140 mm	
Paqu	18	Parthenocissus quinquefolia	Virginia creeper	10 - 15 m	10 - 15 m	140 mm	
Ferns / Shade Perennials			ga c. copo.	.5 15 111	.5 .5		
Doas	360	Doodia aspera	Prickly rasp fern	0.4 m	0.5 m	200 mm	
	919	Dryopteris erythrosora	Autumn fern	0.5 m	0.5 m	200 mm	
Dre	2615						



Albert Street

Sheet Title:	Total Plant Schedule					
Client:	Neometro					
Address:	55 Albert St	55 Albert St, Brunswick East				
Drawn by:	WD	Checked by:	BR			



SPECIFICATIONS IRRIGATION ZONE GROUND LEVEL Apartment G.01 Lower Toro 19mm Drip Tube 2 LPH at 300mm Spacing in Garden Beds Apartment G.02 Lower Toro 19mm Drip Tube 2 LPH at 300mm Spacing in Garden Beds Apartment G.03 Lower Toro 19mm Drip Tube 2 LPH at 300mm Spacing in Garden Beds ZONE 1.4 Apartment G.04 Toro 19mm Drip Tube 2 LPH at 300mm Spacing in Garden Beds ZONE 1.5 Apartment G.05 Toro 19mm Drip Tube 2 LPH at 300mm Spacing in Garden Beds ZONE 1.6 Toro 19mm Drip Tube 2 LPH at 300mm Spacing in Garden Beds Apartment G.06 ZONE 1.7 Apartment G.07 Toro 19mm Drip Tube 2 LPH at 300mm Spacing in Garden Beds ZONE 1.8 Apartment G.08 Lower Toro 19mm Drip Tube 2 LPH at 300mm Spacing in Garden Beds **ZONE 1.9** Apartment G.09 Lower Toro 19mm Drip Tube 2 LPH at 300mm Spacing in Garden Beds ZONE 1.10 Apartment G.10 Lower Toro 19mm Drip Tube 2 LPH at 300mm Spacing in Garden Beds Entrance & Lobby Toro 19mm Drip Tube 2 LPH at 300mm Spacing in Garden Beds



cabinets for easy access and clean installation. Common zone controller controlled by owners corp located within basement service zone. Location to be determined by Architect


Solenoid Location - 19mm diameter mains water supply with gate

valve, located in solenoid box below soil level or in behind access

Controller - 'Hunter Pro HC WiFi' digital controller, located in AV



doors (All solenoid's consolidated in basement service zone) Mains supply tap (500kpa pressure) - 19mm diameter copper supply with chrome tap, wall-mounted at 600mm high

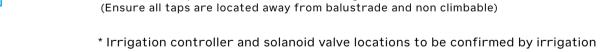

Solanoids valve box to be located subtely out of plain site.

* The irrigation source is to be harvested rainwater, with mains back up

IRRIGATION

1. Irrigation system is to be fully automated, connected to 240volt wall mounted irrigation controller. 2. Irrigation system is to be designed by suitably qualified irrigation / sprinkler

3. Landscape contractor to provide all necessary information to irrigation designer such as: water flow / pressure rate, mains water locations etc.

4. Landscape contractor is to liaise with garden maintenance contractor in programming the irrigation system.


5. No water is to spray onto building. 6. Spray heads to allow clearance of mature plant height, not planting height.


7. All plants to receive even moisture coverage - allow appropriate overlap. 8. Irrigation controller to be located in Services area (consult client prior to installation).

9. All solenoid boxes to be hidden at back of garden beds. All visible sprinkler parts to be grey in colour. Install pressure reduction valve, flush valve & air

10. Contractor is to determine appropriate zone quantity & location based on specific site pressure and planting requirements. Irrigation system is to be fully operational prior to planting.


11. Garden bed / planter irrigation - In-line drippers at 200mm spacings in garden beds and at 100mm spacing between steppers, lines to be set 75mm below finished soil level and set using galvanised steel pegs at 500mm spacings. 12. Irrigation frequency and volumes to be set with particular care and consideration to plant establishment periods of a minimum two years.

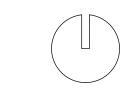

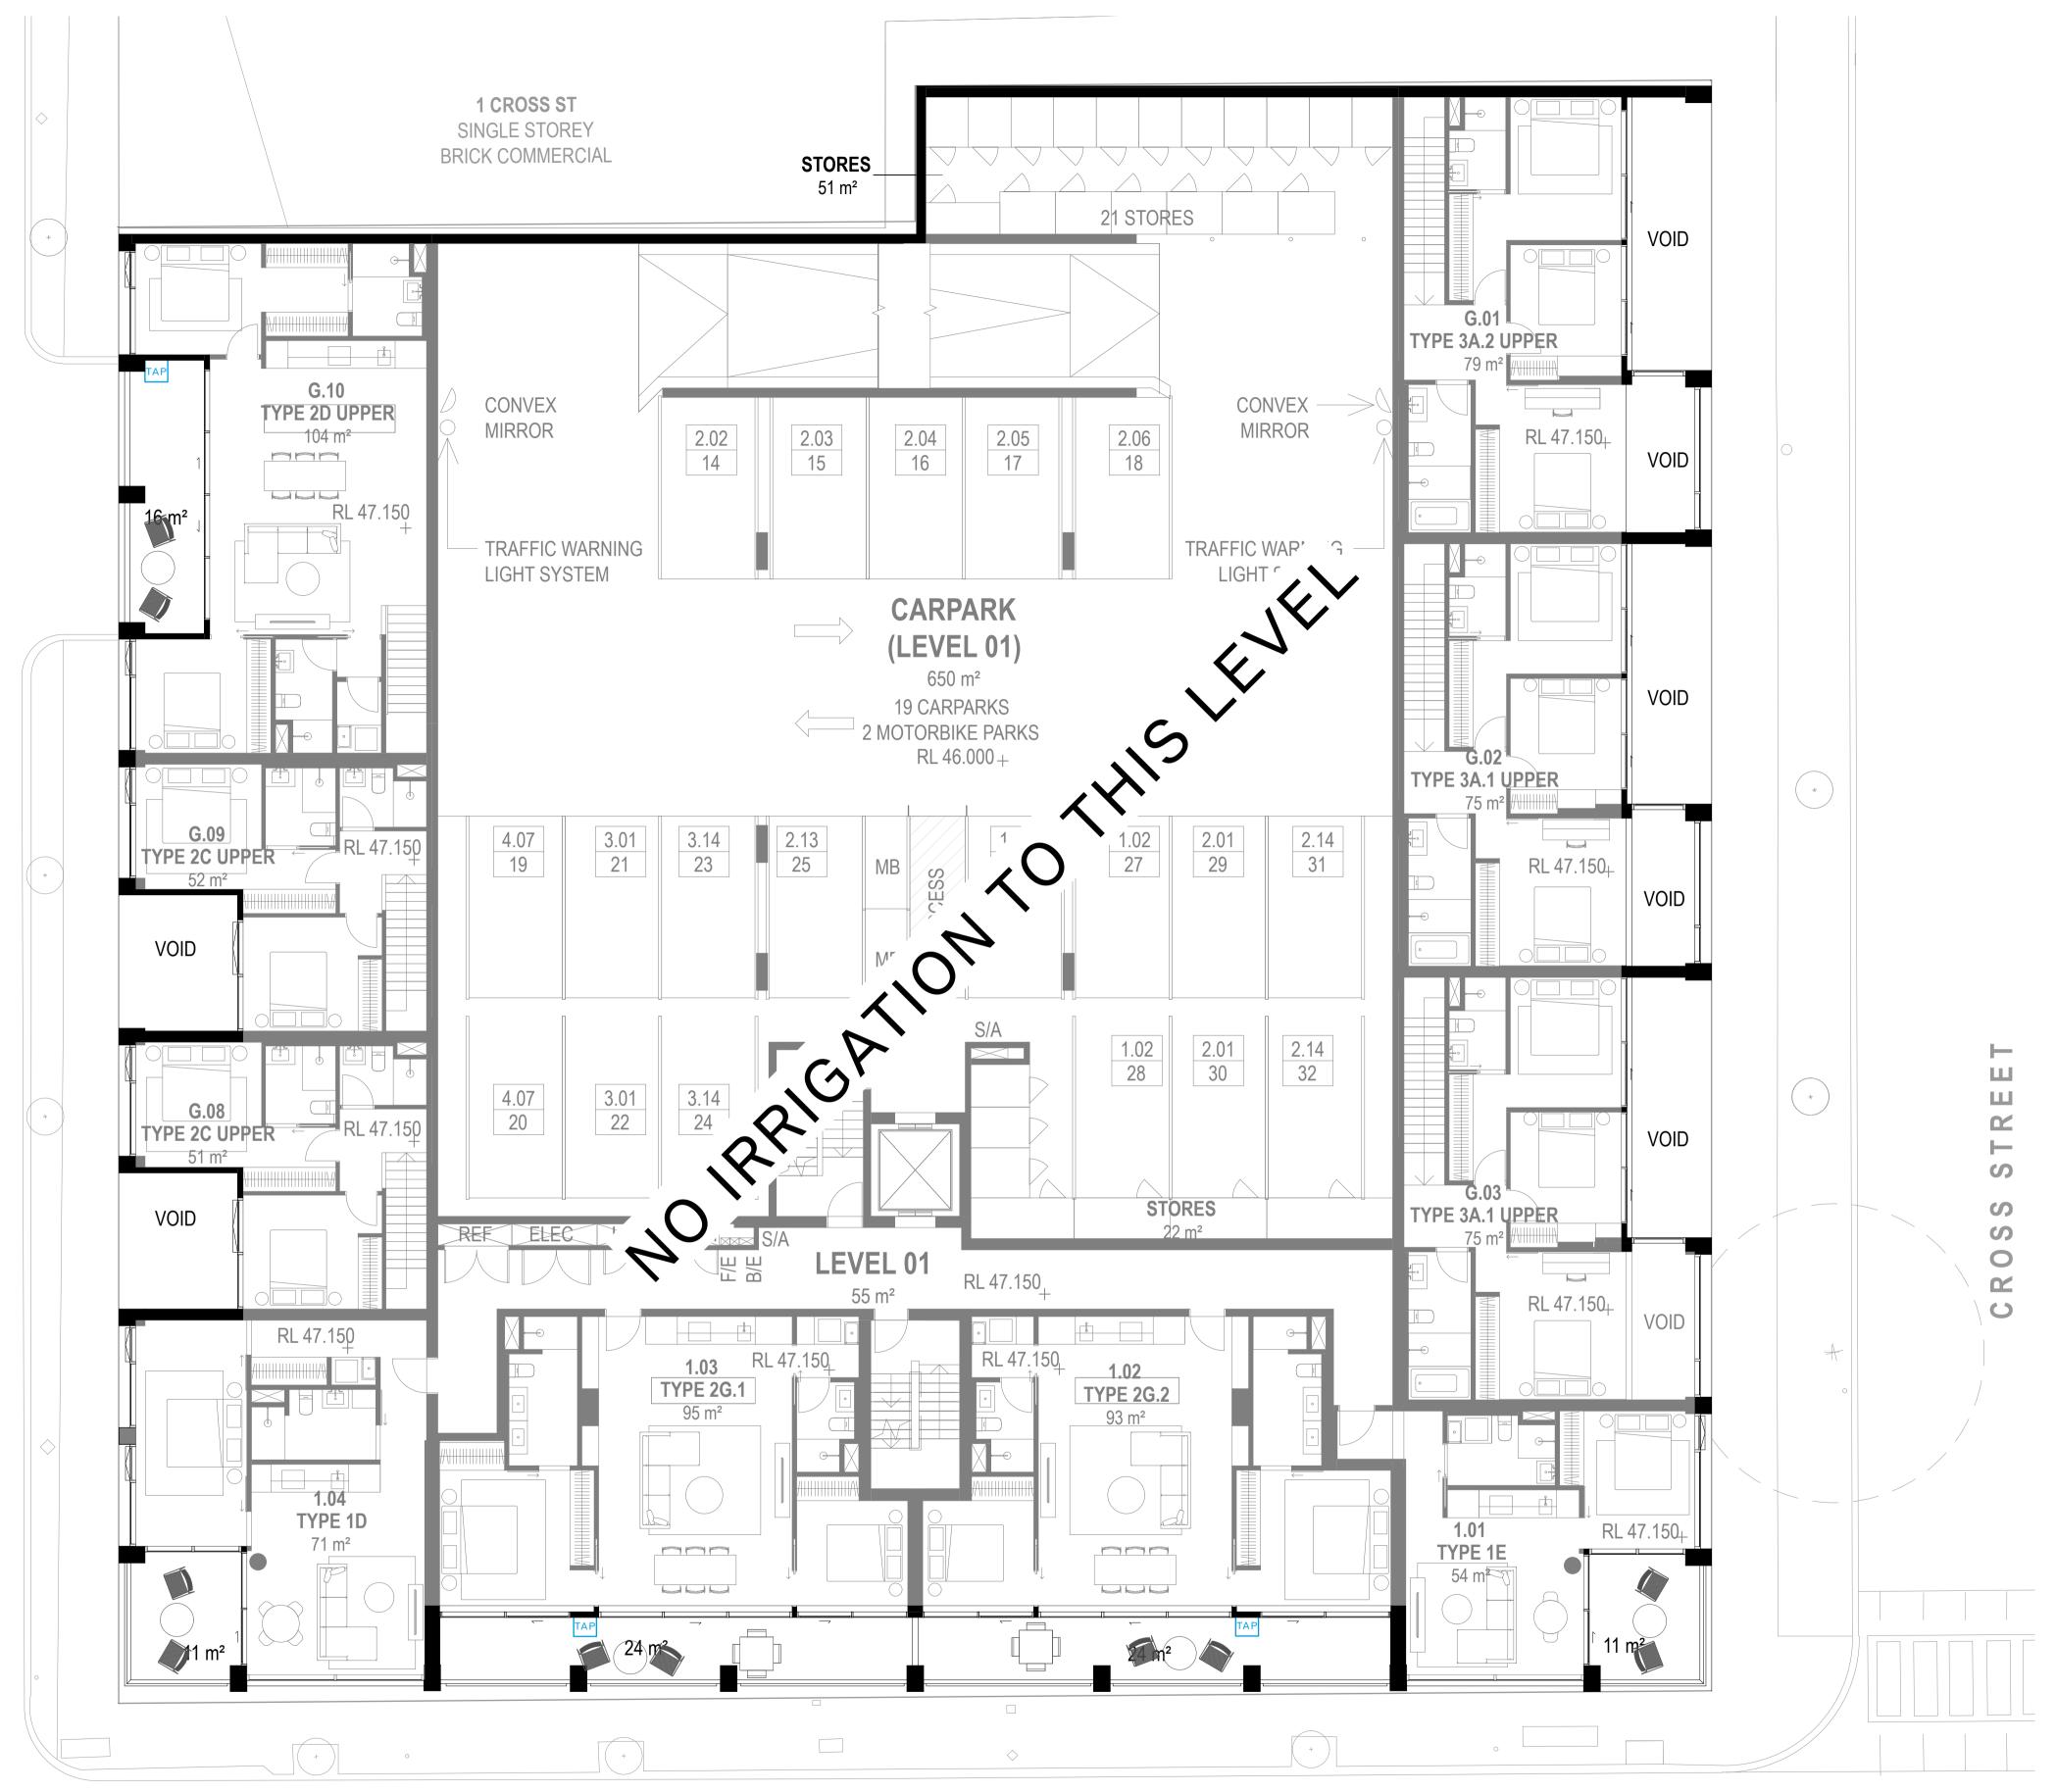

ALBERT STREET

1 Irrigation Plan - Level 1 Scale: 1:100

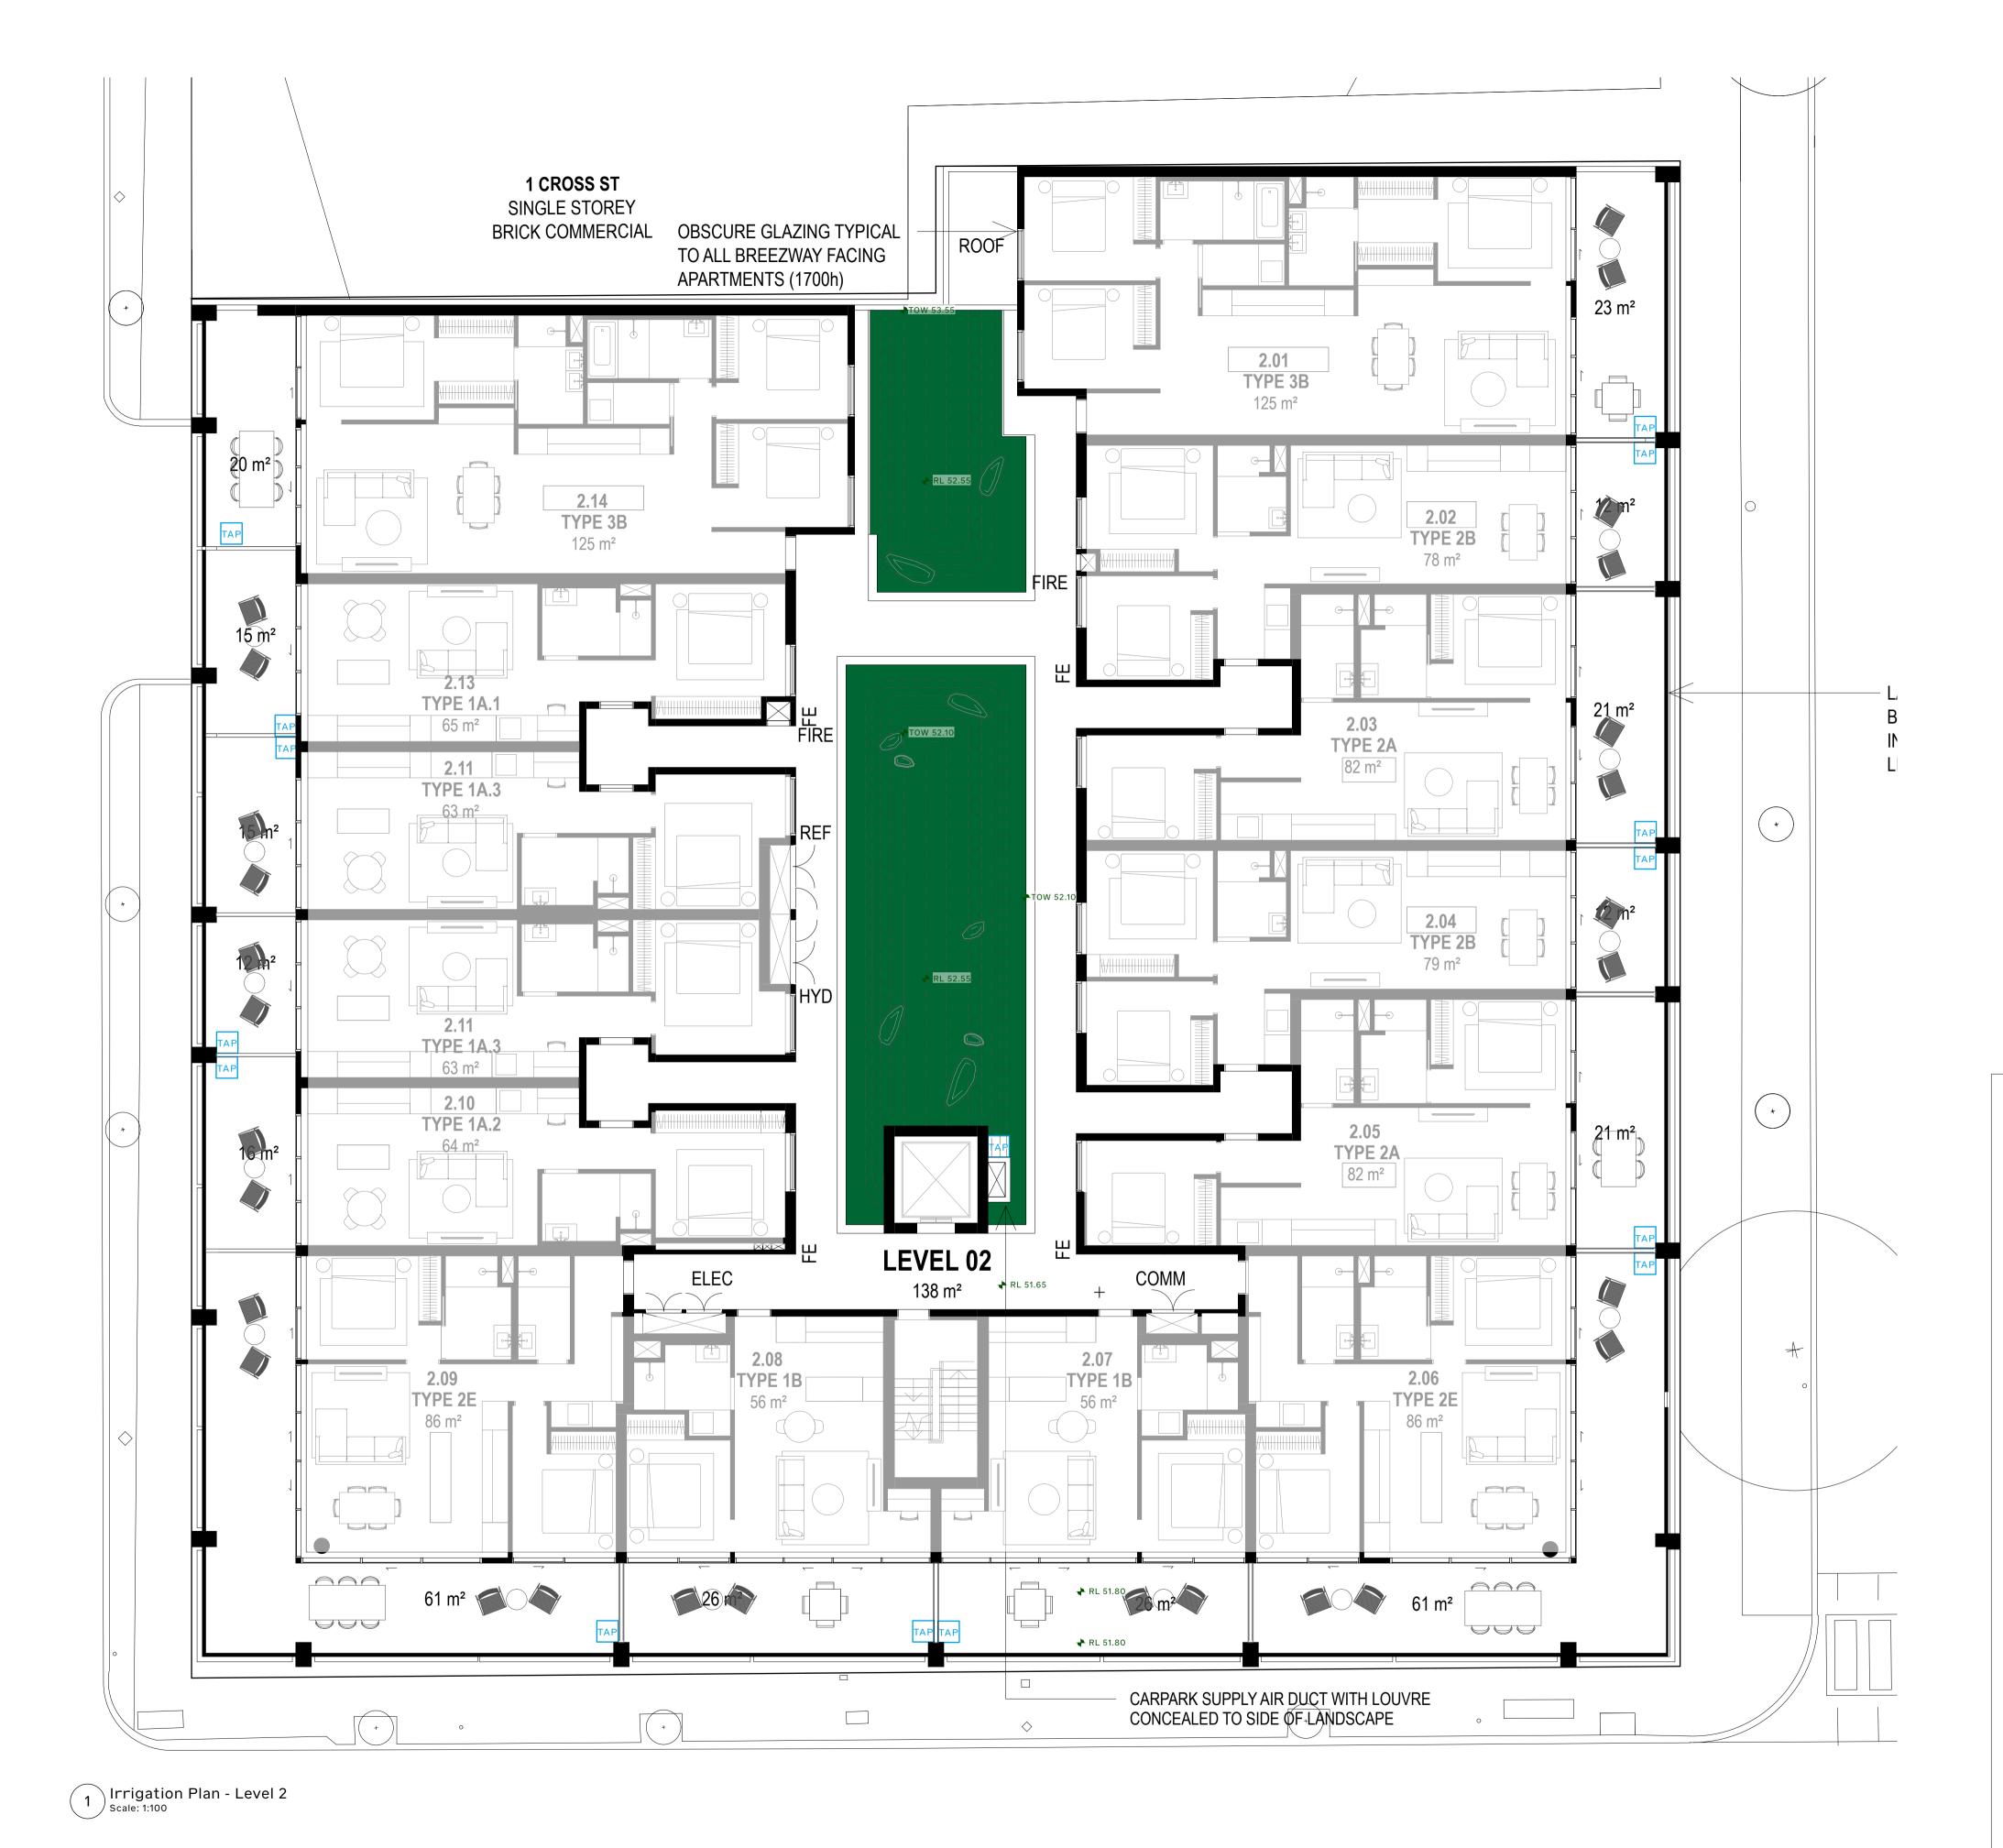

Controller - 'Hunter Pro HC WiFi' digital controller, located in AV cabinets for easy access and clean installation. Common zone CON controller controlled by owners corp located within basement service zone. Location to be determined by Architect SOL Solenoid Location - 19mm diameter mains water supply with gate valve, located in solenoid box below soil level or in behind access doors (All solenoid's consolidated in basement service zone) Mains supply tap (500kpa pressure) - 19mm diameter copper supply with chrome tap, wall-mounted at 600mm high (Ensure all taps are located away from balustrade and non climbable) * Irrigation controller and solanoid valve locations to be confirmed by irrigation Solanoids valve box to be located subtely out of plain site. * The irrigation source is to be harvested rainwater, with mains back up IRRIGATION 1. Irrigation system is to be fully automated, connected to 240volt wall mounted irrigation controller. 2. Irrigation system is to be designed by suitably qualified irrigation / sprinkler specialist. 3. Landscape contractor to provide all necessary information to irrigation designer such as: water flow / pressure rate, mains water locations etc. 4. Landscape contractor is to liaise with garden maintenance contractor in programming the irrigation system. 5. No water is to spray onto building. 6. Spray heads to allow clearance of mature plant height, not planting height. 7. All plants to receive even moisture coverage - allow appropriate overlap. 8. Irrigation controller to be located in Services area (consult client prior to installation). 9. All solenoid boxes to be hidden at back of garden beds. All visible sprinkler parts to be grey in colour. Install pressure reduction valve, flush valve & air 10. Contractor is to determine appropriate zone quantity & location based on specific site pressure and planting requirements. Irrigation system is to be fully operational prior to planting. 11. Garden bed / planter irrigation - In-line drippers at 200mm spacings in garden beds and at 100mm spacing between steppers, lines to be set 75mm

SPECIFICATIONS

Toro 19mm Drip Tube

2 LPH at 300mm Spacing in Garden Beds

IRRIGATION SCHEDULE

IRRIGATION ZONE

Central Courtyard

LEGEND

LEVEL 2

ZONE 2.1

September 16, 2025 Sheet Title: Irrigation Plan - Level 2 Date: Client: Neometro Revision: 4 Address: 55 Albert St, Brunswick East Page Size: A1 Drawn by: WD Checked by: BR TP-4.03 Page:

below finished soil level and set using galvanised steel pegs at 500mm spacings.

12. Irrigation frequency and volumes to be set with particular care and consideration to plant establishment periods of a minimum two years.



IRRIGATION SCHEDULE

IRRIGATION ZONE

Apartment 3.01

Apartment 3.02

Apartment 3.07

Apartment 3.09

Apartment 3.11

LEGEND

LEVEL 3

ZONE 3.7

Toro 19mm Drip Tube 2 LPH at 300mm Spacing in Garden Beds Apartment 3.03 ZONE 3.4 Apartment 3.04 Toro 19mm Drip Tube 2 LPH at 300mm Spacing in Garden Beds ZONE 3.5 Apartment 3.05 Toro 19mm Drip Tube 2 LPH at 300mm Spacing in Garden Beds ZONE 3.6 Apartment 3.06 Toro 19mm Drip Tube 2 LPH at 300mm Spacing in Garden Beds

SPECIFICATIONS

Toro 19mm Drip Tube

Toro 19mm Drip Tube

Toro 19mm Drip Tube

Toro 19mm Drip Tube 2 LPH at 300mm Spacing in Garden Beds

2 LPH at 300mm Spacing in Garden Beds

2 LPH at 300mm Spacing in Garden Beds ZONE 3.8 Apartment 3.08 Toro 19mm Drip Tube 2 LPH at 300mm Spacing in Garden Beds ZONE 3.9

Toro 19mm Drip Tube 2 LPH at 300mm Spacing in Garden Beds ZONE 3.10 Apartment 3.10 Toro 19mm Drip Tube 2 LPH at 300mm Spacing in Garden Beds

2 LPH at 300mm Spacing in Garden Beds Toro 19mm Drip Tube Apartment 3.12 2 LPH at 300mm Spacing in Garden Beds

Toro 19mm Drip Tube 2 LPH at 300mm Spacing in Garden Beds Apartment 3.13 ZONE 3.14 Apartment 3.14 Toro 19mm Drip Tube 2 LPH at 300mm Spacing in Garden Beds



CON

Solenoid Location - 19mm diameter mains water supply with gate valve, located in solenoid box below soil level or in behind access doors (All solenoid's consolidated in basement service zone)

Solanoids valve box to be located subtely out of plain site.

Controller - 'Hunter Pro HC WiFi' digital controller, located in AV

cabinets for easy access and clean installation. Common zone

controller controlled by owners corp located within basement

service zone. Location to be determined by Architect

Mains supply tap (500kpa pressure) - 19mm diameter copper supply with chrome tap, wall-mounted at 600mm high (Ensure all taps are located away from balustrade and non climbable)

* Irrigation controller and solanoid valve locations to be confirmed by irrigation

* The irrigation source is to be harvested rainwater, with mains back up

IRRIGATION

1. Irrigation system is to be fully automated, connected to 240volt wall mounted irrigation controller. 2. Irrigation system is to be designed by suitably qualified irrigation / sprinkler

specialist. 3. Landscape contractor to provide all necessary information to irrigation

designer such as: water flow / pressure rate, mains water locations etc. 4. Landscape contractor is to liaise with garden maintenance contractor in programming the irrigation system.

5. No water is to spray onto building. 6. Spray heads to allow clearance of mature plant height, not planting height.

7. All plants to receive even moisture coverage - allow appropriate overlap. 8. Irrigation controller to be located in Services area (consult client prior to installation). 9. All solenoid boxes to be hidden at back of garden beds. All visible sprinkler

parts to be grey in colour. Install pressure reduction valve, flush valve & air 10. Contractor is to determine appropriate zone quantity & location based on

specific site pressure and planting requirements. Irrigation system is to be fully operational prior to planting.

11. Garden bed / planter irrigation - In-line drippers at 200mm spacings in garden beds and at 100mm spacing between steppers, lines to be set 75mm below finished soil level and set using galvanised steel pegs at 500mm spacings. 12. Irrigation frequency and volumes to be set with particular care and consideration to plant establishment periods of a minimum two years.

September 16, 2025 Sheet Title: Irrigation Plan - Level 3 Date: Client: Neometro Revision: 4 Address: 55 Albert St, Brunswick East Page Size: A1 Drawn by: WD Checked by: BR TP-4.04 Page:

Acre Architecture for Landscapes

Albert Street

These are conceptual drawings only. Acre Landscape Architecture Studio will not be held responsible for any structural works constructed from these drawings. All dimensions to be confirmed on site by contractor prior to commencement of works.

1 Irrigation Plan - Level 3

IRRIGATION SCHEDULE **LEGEND** IRRIGATION ZONE SPECIFICATIONS LEVEL 4 Apartment 4.01 Toro 19mm Drip Tube 2 LPH at 300mm Spacing in Garden Beds Apartment 4.02 Toro 19mm Drip Tube 2 LPH at 300mm Spacing in Garden Beds Apartment 4.03 Toro 19mm Drip Tube 2 LPH at 300mm Spacing in Garden Beds Controller - 'Hunter Pro HC WiFi' digital controller, located in AV cabinets for easy access and clean installation. Common zone CON controller controlled by owners corp located within basement service zone. Location to be determined by Architect SOL Solenoid Location - 19mm diameter mains water supply with gate valve, located in solenoid box below soil level or in behind access doors (All solenoid's consolidated in basement service zone) Mains supply tap (500kpa pressure) - 19mm diameter copper supply with chrome tap, wall-mounted at 600mm high (Ensure all taps are located away from balustrade and non climbable) * Irrigation controller and solanoid valve locations to be confirmed by irrigation Solanoids valve box to be located subtely out of plain site. * The irrigation source is to be harvested rainwater, with mains back up

IRRIGATION 1. Irrigation system is to be fully automated, connected to 240volt wall mounted

irrigation controller. 2. Irrigation system is to be designed by suitably qualified irrigation / sprinkler specialist. 3. Landscape contractor to provide all necessary information to irrigation

designer such as: water flow / pressure rate, mains water locations etc. 4. Landscape contractor is to liaise with garden maintenance contractor in programming the irrigation system.

5. No water is to spray onto building. 6. Spray heads to allow clearance of mature plant height, not planting height. 7. All plants to receive even moisture coverage - allow appropriate overlap. 8. Irrigation controller to be located in Services area (consult client prior to


installation). 9. All solenoid boxes to be hidden at back of garden beds. All visible sprinkler parts to be grey in colour. Install pressure reduction valve, flush valve & air

10. Contractor is to determine appropriate zone quantity & location based on specific site pressure and planting requirements. Irrigation system is to be fully operational prior to planting.

11. Garden bed / planter irrigation - In-line drippers at 200mm spacings in garden beds and at 100mm spacing between steppers, lines to be set 75mm below finished soil level and set using galvanised steel pegs at 500mm spacings. 12. Irrigation frequency and volumes to be set with particular care and consideration to plant establishment periods of a minimum two years.

September 16, 2025 Sheet Title: Irrigation Plan - Level 4 Date: Client: Neometro Revision: 4 Address: 55 Albert St, Brunswick East Page Size: A1 Drawn by: WD Checked by: BR TP-4.05 Page:

1 Irrigation Plan - Level 4
Scale: 1:100

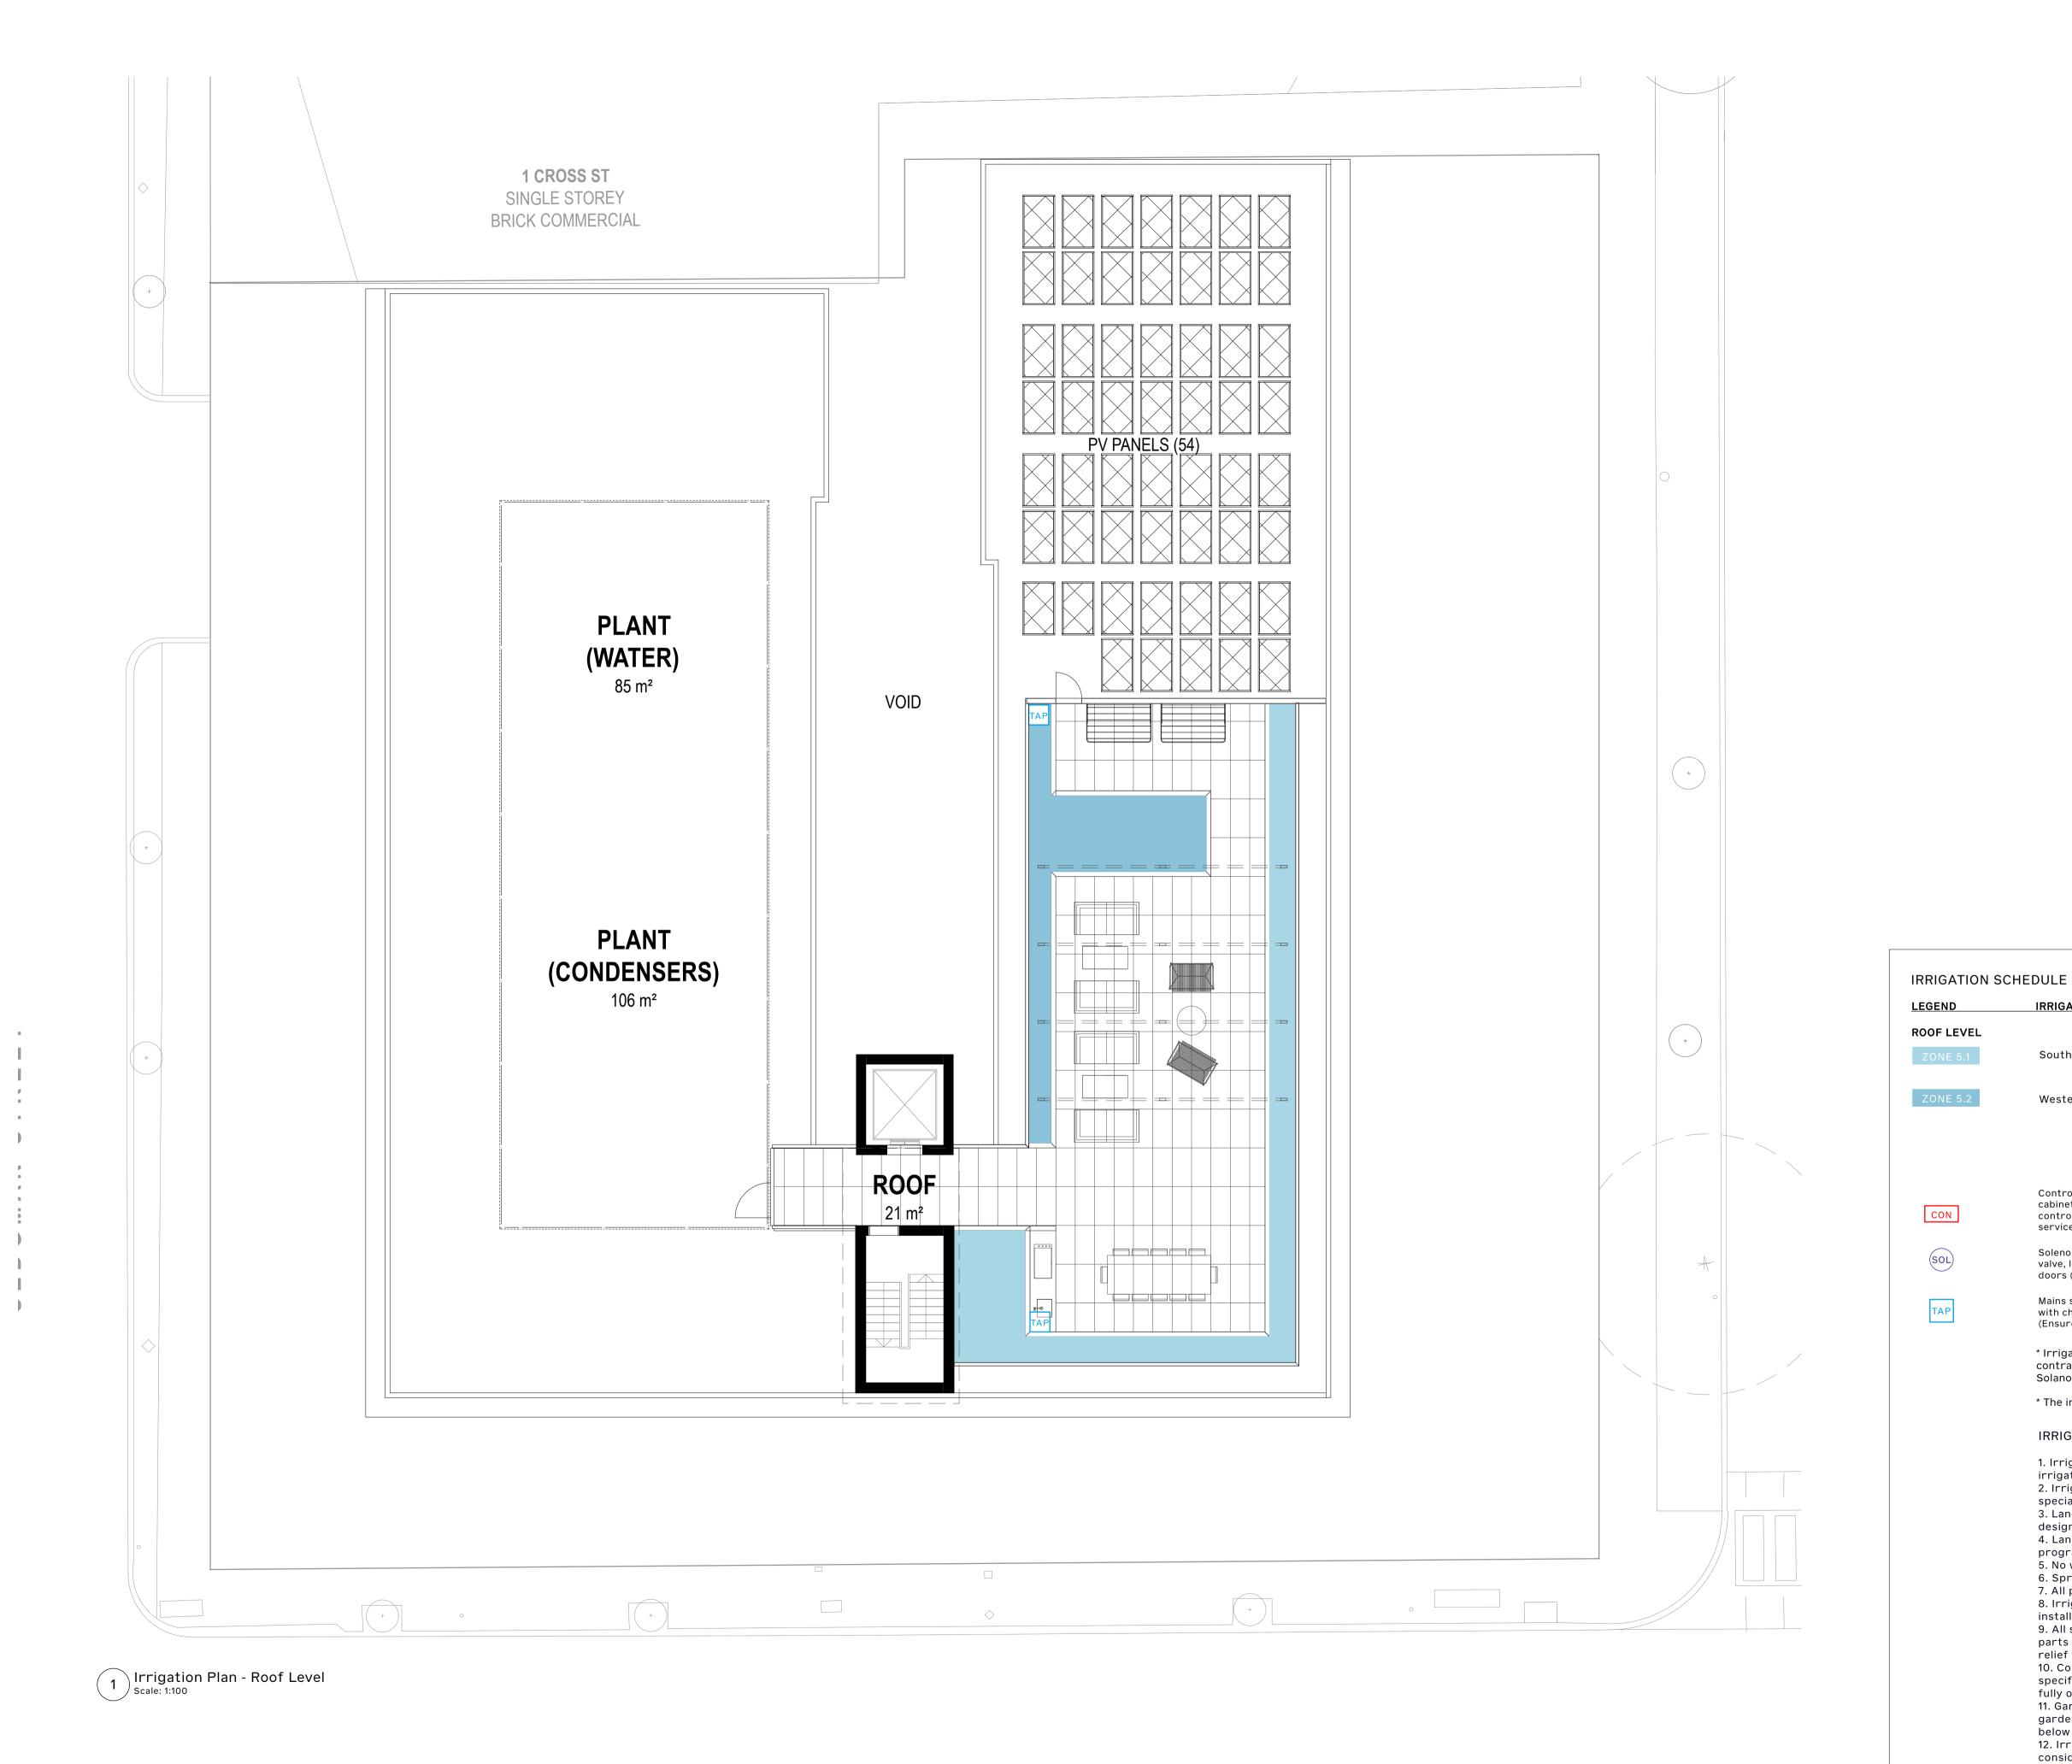

ROOF LEVEL South Eastern Planter Toro 19mm Drip Tube 2 LPH at 300mm Spacing in Garden Beds Western Planters Toro 19mm Drip Tube 2 LPH at 300mm Spacing in Garden Beds Controller - 'Hunter Pro HC WiFi' digital controller, located in AV cabinets for easy access and clean installation. Common zone CON controller controlled by owners corp located within basement service zone. Location to be determined by Architect Solenoid Location - 19mm diameter mains water supply with gate SOL valve, located in solenoid box below soil level or in behind access doors (All solenoid's consolidated in basement service zone) Mains supply tap (500kpa pressure) - 19mm diameter copper supply with chrome tap, wall-mounted at 600mm high (Ensure all taps are located away from balustrade and non climbable) * Irrigation controller and solanoid valve locations to be confirmed by irrigation Solanoids valve box to be located subtely out of plain site. * The irrigation source is to be harvested rainwater, with mains back up IRRIGATION 1. Irrigation system is to be fully automated, connected to 240volt wall mounted irrigation controller. 2. Irrigation system is to be designed by suitably qualified irrigation / sprinkler specialist. 3. Landscape contractor to provide all necessary information to irrigation designer such as: water flow / pressure rate, mains water locations etc. 4. Landscape contractor is to liaise with garden maintenance contractor in programming the irrigation system. 5. No water is to spray onto building. 6. Spray heads to allow clearance of mature plant height, not planting height. 7. All plants to receive even moisture coverage - allow appropriate overlap. 8. Irrigation controller to be located in Services area (consult client prior to installation). 9. All solenoid boxes to be hidden at back of garden beds. All visible sprinkler parts to be grey in colour. Install pressure reduction valve, flush valve & air 10. Contractor is to determine appropriate zone quantity & location based on specific site pressure and planting requirements. Irrigation system is to be fully operational prior to planting. 11. Garden bed / planter irrigation - In-line drippers at 200mm spacings in garden beds and at 100mm spacing between steppers, lines to be set 75mm below finished soil level and set using galvanised steel pegs at 500mm spacings. 12. Irrigation frequency and volumes to be set with particular care and consideration to plant establishment periods of a minimum two years.

IRRIGATION ZONE

SPECIFICATIONS

Client: Neometro





Elevations - South

Sheet Title: Elevation-South Date: September 16, 2025 Neometro Revision: 4 Client: Address: 55 Albert St, Brunswick East Page Size: A1 Drawn by: WD TP-5.01 Checked by: BR Page:



1 Elevation - East Scale: 1:100

Sheet Title: Elevation - East Date: September 16, 2025 Client: Neometro Revision: 4 Address: 55 Albert St, Brunswick East Page Size: A1 Drawn by: WD Page: TP-5.02 Checked by: BR



1 Elevation - West Scale: 1:100

acre.com.au @acre.landscape

Acre

Sheet Title: Elevation - West


Client: Neometro

Revision: 4

Address: 55 Albert St, Brunswick East


Drawn by: WD Checked by: BR


Page: TP-5.03

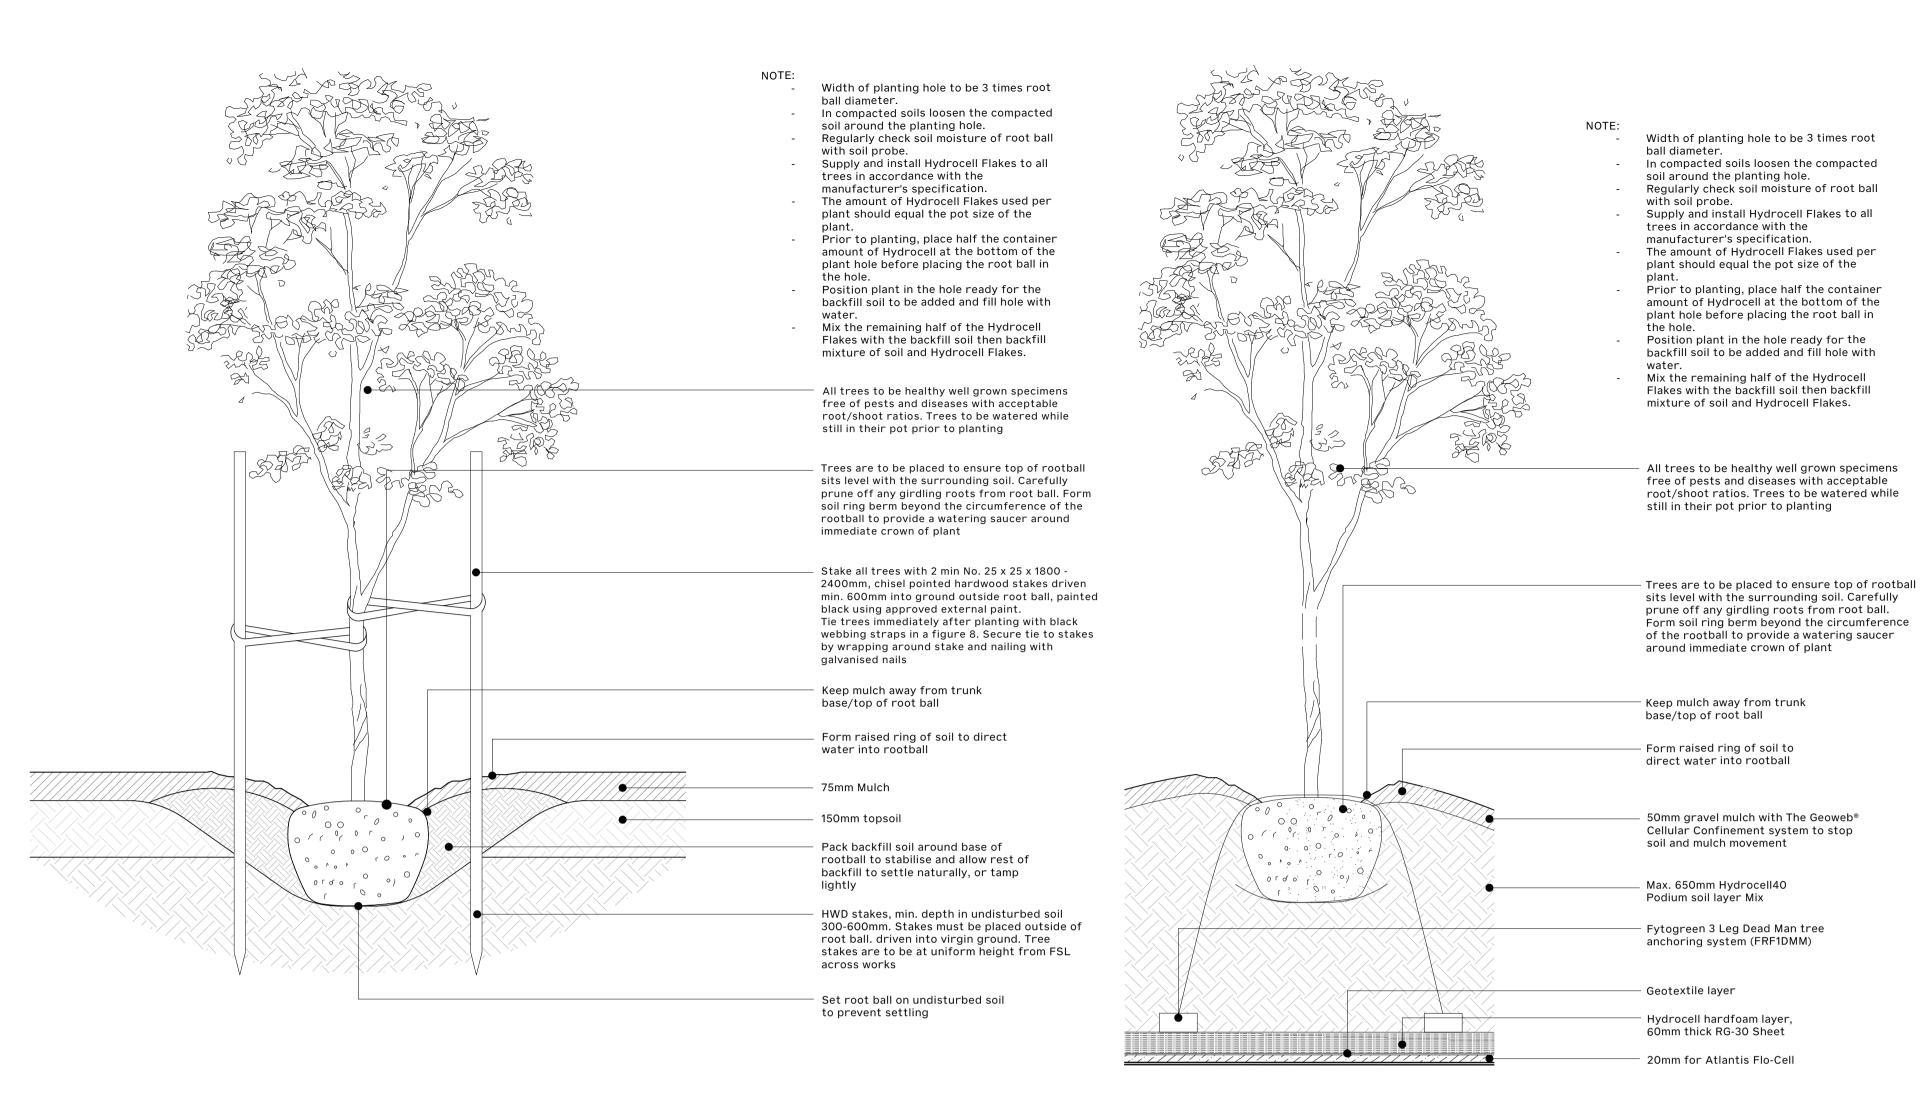


Typical Details - Tree Planting



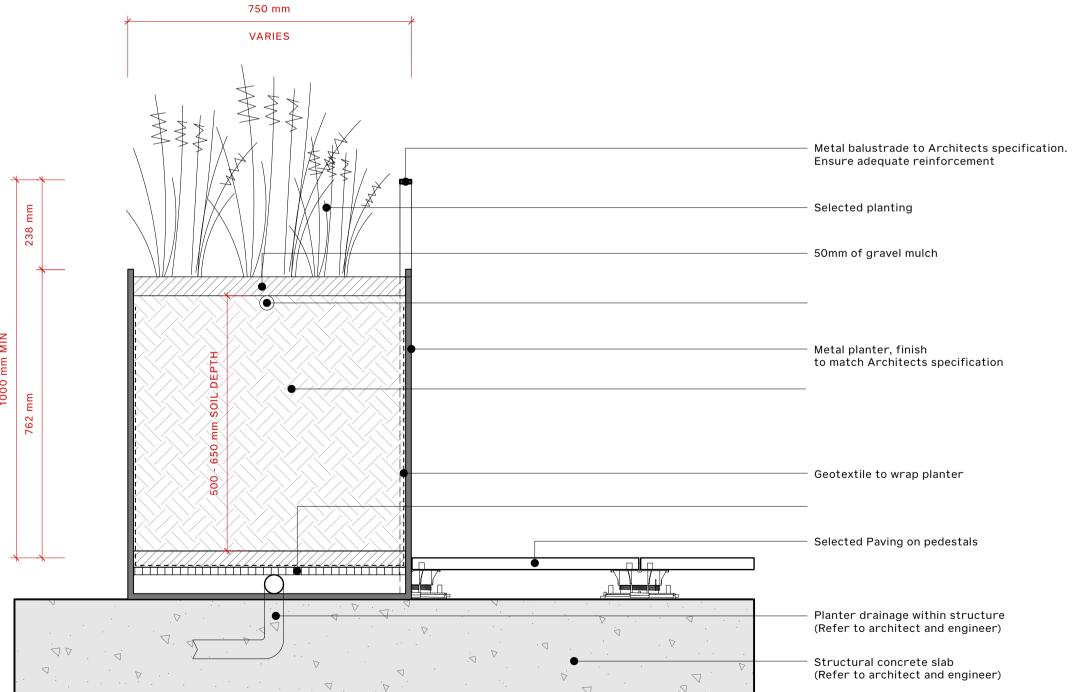

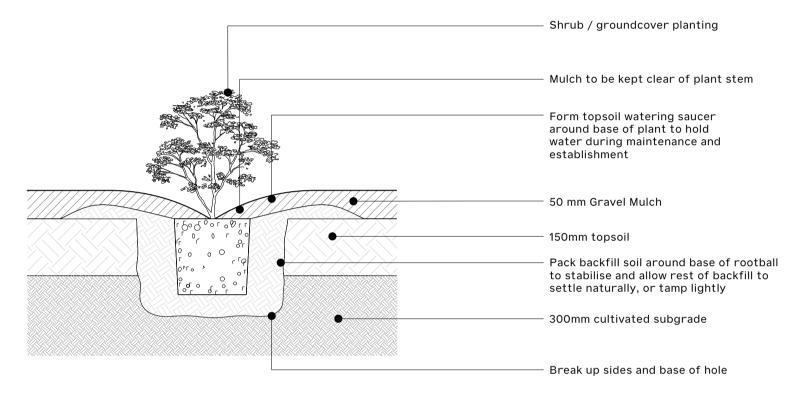

Typical Detail - Shrub Planting
Scale: 1:10

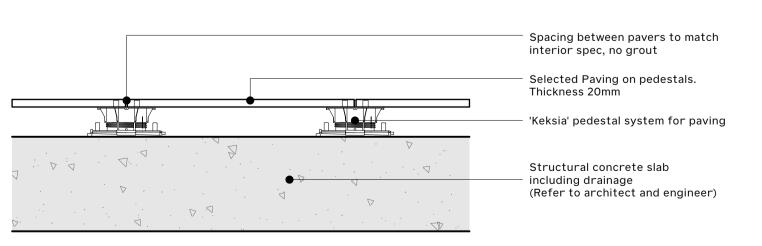

6 Typical Detail - Terrace Paver on Pedestal System

5	Typical Detail - Terrace Balustrade Planter [Standard]	

Typical Detail - Lightweight Media [Planter on Structure]

